GENERAL NOTES

- ELEVATIONS SHOWN ARE IN US FEET, NATIONAL AMERICAN VERTICAL DATUM OF 1988.
- STATIONS SHOWN ON DRAWINGS ARE ALONG CENTERLINE OF PROPOSED STORM DRAIN.
- E.G.L. AND H.G.L. WILL BE PROVIDED IN FINAL ENGINEERING FOR FUTURE REFERENCE BY THE DISTRICT ONLY.
- NUMBERS IN (-) INDICATE BID ITEMS FOR WHICH PAYMENT WILL BE MADE.
- 5. LETTER AND NUMBER IN $\begin{pmatrix} \\ \end{pmatrix}$ INDICATE THE DETAIL CALL-OUT AND SHEET ON WHICH REFERENCE DETAIL IS SHOWN.
- 6. NUMBERS IN \bigwedge REFER TO NOTES ON SAME SHEET UNLESS OTHERWISE NOTED.
- 7. TREES DESIGNATED BY SHALL BE REMOVED. ALL OTHER TREES SHALL BE PROTECTED IN PLACE UNLESS INDICATED OTHERWISE.
- DELINEATES LIMITS OF TEMPORARY WORK AREA.
- 10. TOPOGRAPHY AND CROSS SECTIONS FOR THIS PROJECT WERE TAKEN FROM SURVEYS DATED IN 10/17/2022.
- 11. SYMBOL A INDICATES THE LOCATION OF HORIZONTAL AND VERTICAL CONTROL POINTS WHICH WILL BE FURNISHED BY THE AGENCY FOR CONSTRUCTION USE.

SURVEY CONTROL POINTS

PT 249	NORTHING/Y:	1,911,567.341	EASTING/X:	6,211,045.479	ELEV/Z:	93.148
PT 250	NORTHING/Y:	1,911,952.172	EASTING/X:	6,211,396.378	ELEV/Z:	93.64
PT 251	NORTHING/Y:	1,910,987.226	EASTING/X:	6,210,537.528	ELEV/Z:	90.62
PT 252	NORTHING/Y:	1,910,639.504	EASTING/X:	6,210,250.829	ELEV/Z:	89.26
PT 253	NORTHING/Y:	1,910,837.597	EASTING/X:	6,211,393.810	ELEV/Z:	92.59
PT 254	NORTHING/Y:	1,910,169.232	EASTING/X:	6,210,821.267	ELEV/Z:	92.56
PT 255	NORTHING/Y:	1,910,232.298	EASTING/X:	6,209,896.833	ELEV/Z:	88.79
PT 1780	NORTHING/Y:	1,911,990,109	EASTING/X:	6,211,389.015	ELEV/Z:	94.20

A VENTURA COUNTY BRASS DISK AT THE SOUTHEAST CORNER OF ROSE AVE. AND ORANGE DRIVE AT THE SCHOOL ENTRANCE, 49 FT EASTERLY FROM THE CENTER OF ROSE AVE., 5 FT EASTERLY FROM THE WESTERLY END OF A CONCRETE SIDEWALK CORNER


- 12. SOIL TEST BORINGS SHOWN FOR THE PROJECT WERE MADE ON AUGUST 11, 2022 AND THEIR LOCATION IS MARKED BY THE SYMBOL . REFER TO THE SPECIFICATIONS FOR ADDITIONAL GEOTECHNICAL REPORT INFORMATION. SUBSURFACE SOIL INVESTIGATION RESULTS ARE FURNISHED FOR INFORMATION ONLY IN ACCORDANCE WITH SUBSECTION 2-7 OF THE STANDARD SPECIFICATIONS, AND NO WARRANTY IS MADE THEREFOR.
- 13. EXISTING IMPROVEMENTS WITHIN THE RIGHT OF WAY AND WORK AREAS SHALL REMAIN AND SHALL BE PROTECTED UNLESS OTHERWISE NOTED. DAMAGED IMPROVEMENTS SHALL BE REPLACED IN KIND TO A CONDITION EQUAL TO OR BETTER THAN THAT WHICH EXISTED PRIOR TO CONSTRUCTION.
- 14. UTILITIES ARE SHOWN AS KNOWN TO EXIST AT TIME OF SURVEY. UTILITIES MAY HAVE BEEN OMITTED, MISPLACED, AND/OR RELOCATED. CONTRACTOR SHALL EXERCISE CARE IN EXCAVATION AND SHALL PROTECT ALL UTILITIES.
- 15. CONTRACTOR SHALL NOTIFY UTILITY OWNERS A MINIMUM OF 48 HOURS PRIOR TO STARTING WORK IN AREAS AFFECTING THEIR FACILITIES.

VENTURA COUNTY PUBLIC WORKS AGENCY WATERSHED PROTECTION

ZONE 2

EL RIO STORMWATER CAPTURE AND GROUNDWATER RECHARGE

IN UNINCORPORATED VENTURA COUNTY

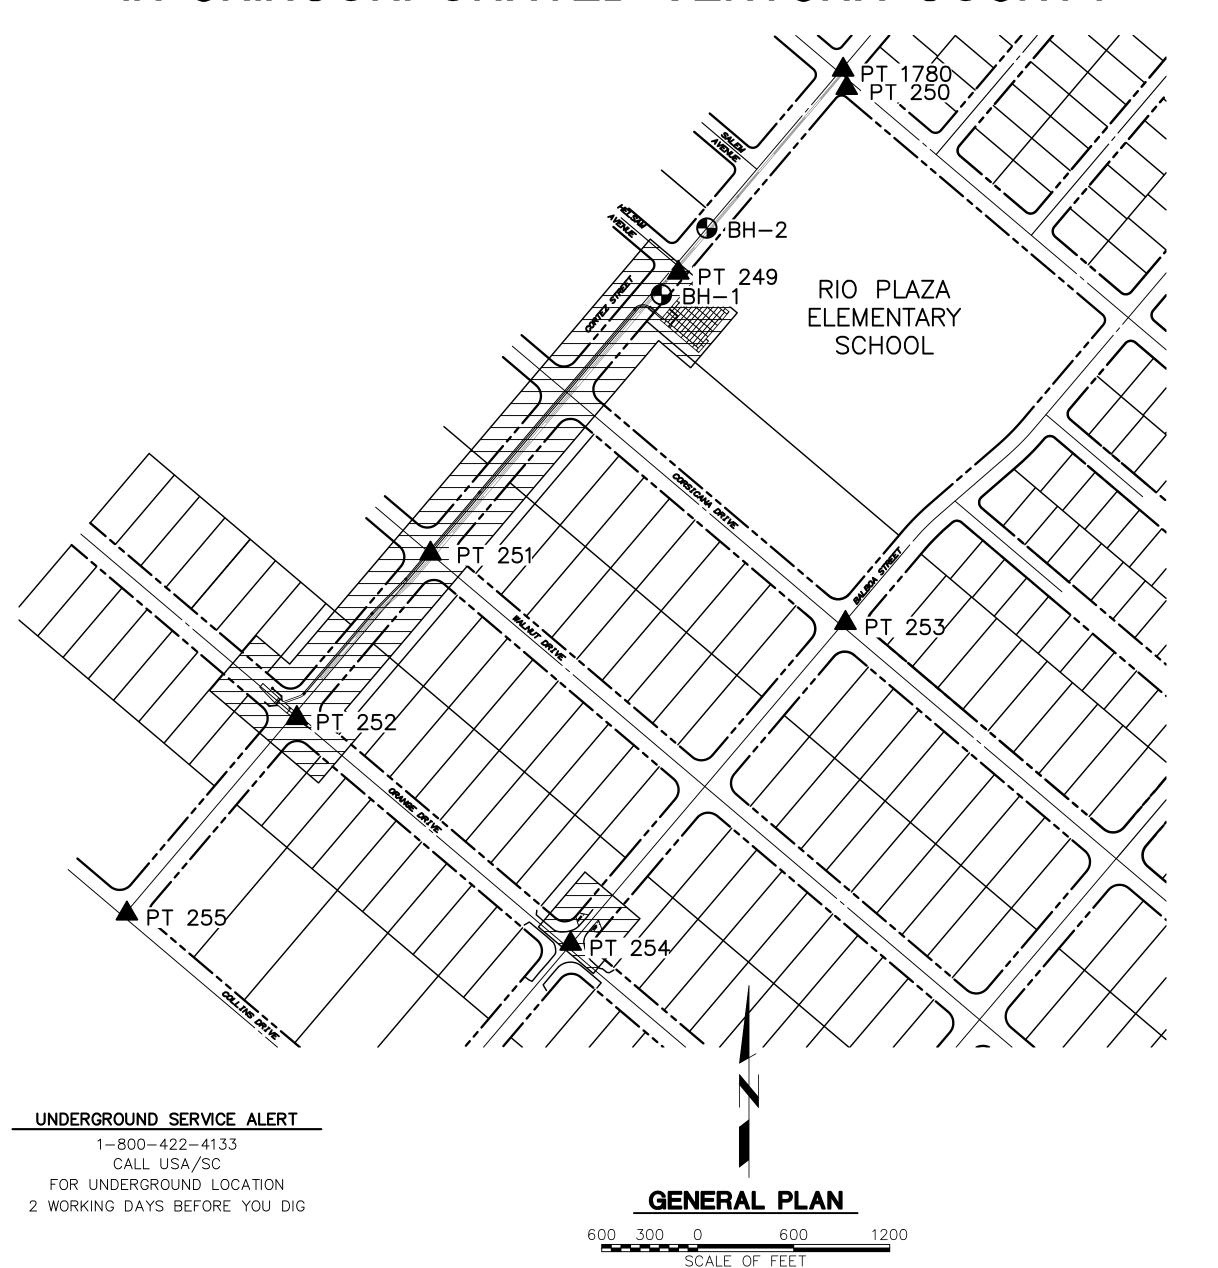

INDEX OF SHEETS

SHEET No	TITLE
1	TITLE SHEET
2	INDEX AND CONSTRUCTION NOTES
3	STORM DRAIN PLAN AND PROFILE
4	STORM DRAIN PLAN AND PROFILE
5	STREET IMPROVEMENTS
6	ROUGH GRADING
7	TRANSITION STRUCTURE DETAIL
8	DETAILS
9	DETAILS
10	PRETREATMENT DETAILS
11	INFILTATION CHAMBER DETAILS 1
12	INFILTATION CHAMBER DETAILS 2

INDEX OF STANDARD PLANS **USED BY REFERENCE**

INFILTATION CHAMBER DETAILS 3

SPPWC STANDARD PLANS, 2021 EDITION:

TYPE A1 CURB TYPE A2 CURB AND GUTTER

CONNECTIONS TO EXISTING STORM DRAINS - CASE 2

CONCRETE COLLAR FOR RCP


COUNTY OF VENTURA PUBLIC WORKS ROAD STANDARDS

E-11 PAVEMENT REPAIRS FOR TRENCHING

RECORD DRAWINGS

DRAWING NO. 67601 TO 67608 "RECORD DRAWING" DRAWING NO. 111963 TO 111971A "RECORD DRAWING"

30% DESIGN NOT FOR CONSTRUCTION

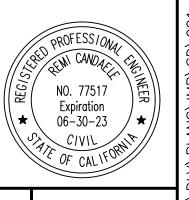

\wedge	REVISION DESCRIPTION	APP.	DATE
Α	ISSUED FOR FEASIBILITY STUDY		11-29-22
В			
С			
D			



Consulting 27042 TOWNE CENTRE DRIVE, SUITE 110 FOOTHILL RANCH, CA 92610 949-259-6770

DESIGNED WATERSHED PROJECT MANAGER AR DRAWN WATERSHED DEPUTY DIRECTOR WATERSHED DIRECTOR

VENTURA COUNTY PUBLIC WORKS AGENCY WATERSHED PROTECTION

N/A PROJ. NO. N/A

EL RIO STORMWATER CAPTURE AND **GROUNDWATER RECHARGE**

TITLE SHEET

SHEET ___ 13 DRAWING NO. WP-?-???

ABBREVIATIONS

AC ASPHALTIC CONCRETE ASTM AMERICAN SOCIETY FOR TESTING & MATERIALS CB CATCH BASIN CD CURB DRAIN CF CURB FACE CENTERLINE C/L OR CL CLEANOUT CONC CONCRETE CP CONTROL POINT CRB CURB DRILL HOLE DIA DIAMETER DRWY DRIVEWAY ELEV ELEVATION EΧ **EXISTING** FG FINISH GRADE FΗ FIRE HYDRANT FLOW LINE FNC FENCE GAS GV GAS VALVE INVERT OR FLOW LINE OF PIPE INV LENGTH LINEAR FEET MAXIMUM MAXMB MAIL BOX MIN MINIMUM POLYVINYL CHLORIDE POWER POLE PPA POWER POLE ANCHOR RADIUS RIGHT OF WAY SEWER SD STORM DRAIN SDMH STORM DRAIN MANHOLE SHT SHEET SMH SEWER MANHOLE SP SIGN POST SPPWC STANDARD PLANS FOR PUBLIC WORKS

CONSTRUCTION

TOP OF CURB

VERTICAL HEIGHT

WATER METER

WATER VALVE

SQUARE

TOTAL

TYPICAL

WATER

TREE


STANDARD


SQ


STD

TC TOT

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CORTEZ STREET UTILITY LOCATIONS VARY PER STREET SECTION. OVERHEAD UTILITIES CROSS ROADWAY IN MULTIPLE

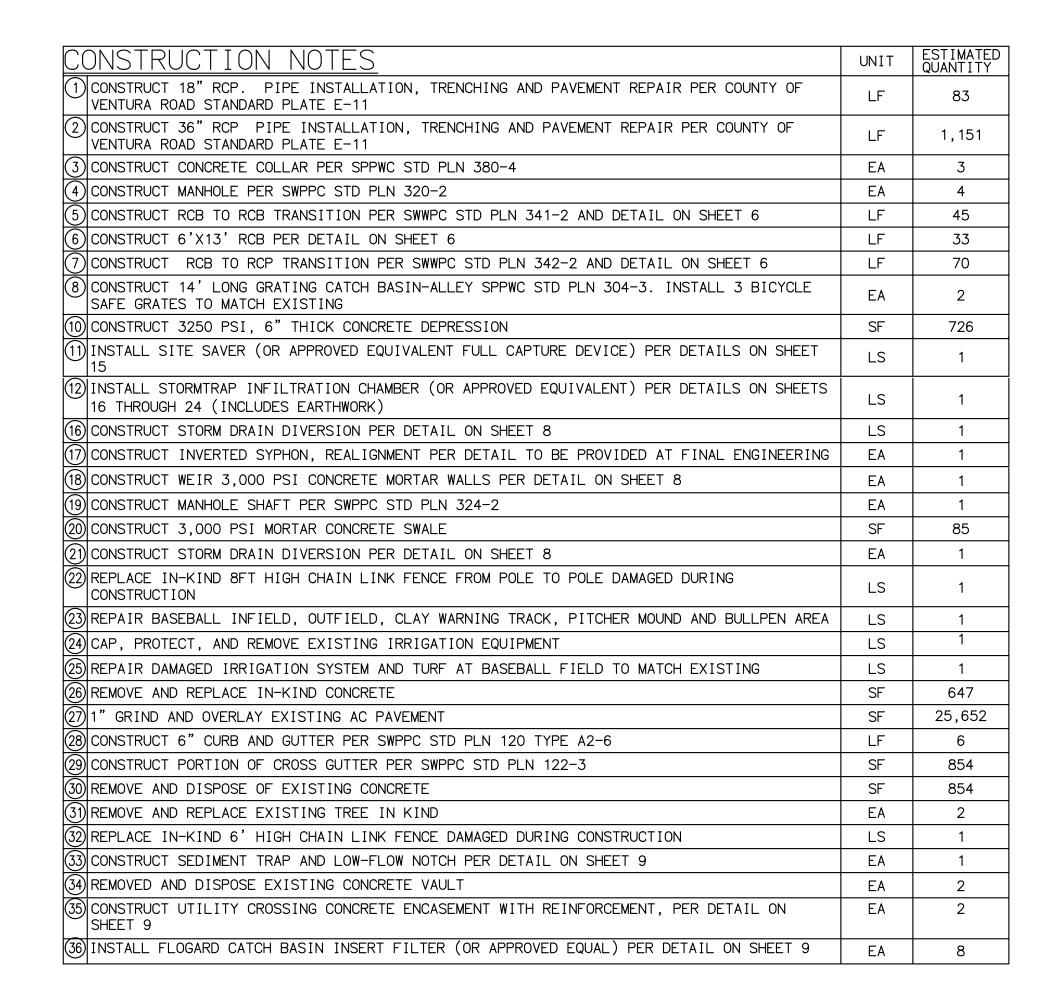LOCATIONS. CONTRACTOR TO PROTECT IN PLACE.

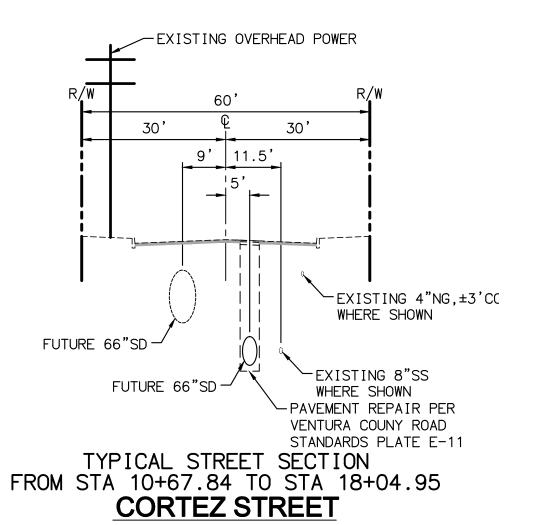30% DESIGN NOT FOR CONSTRUCTION

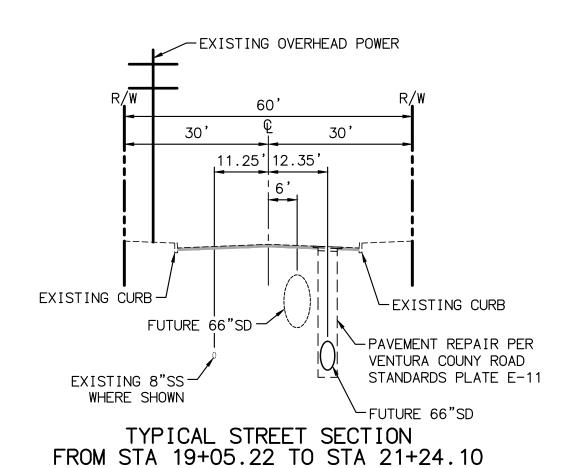	REVISION DESCRIPTION	APP.	DATE	
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UTILITY LOCATIONS VARY PER STREET SECTION.

OVERHEAD UTILITIES CROSS ROADWAY IN MULTIPLE LOCATIONS. CONTRACTOR TO PROTECT IN PLACE.

PREPARED BY:


Consulting 042 TOWNE CENTRE DRIVE, SUITE 110 FOOTHILL RANCH, CA 92610 949-259-6770


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ESIGNED	WATERSHED PROJECT MANAGER	DATE
AR		
RAWN	WATERSHED DEPUTY DIRECTOR	DATE
RC		
HECKED	WATERSHED DIRECTOR	DATE
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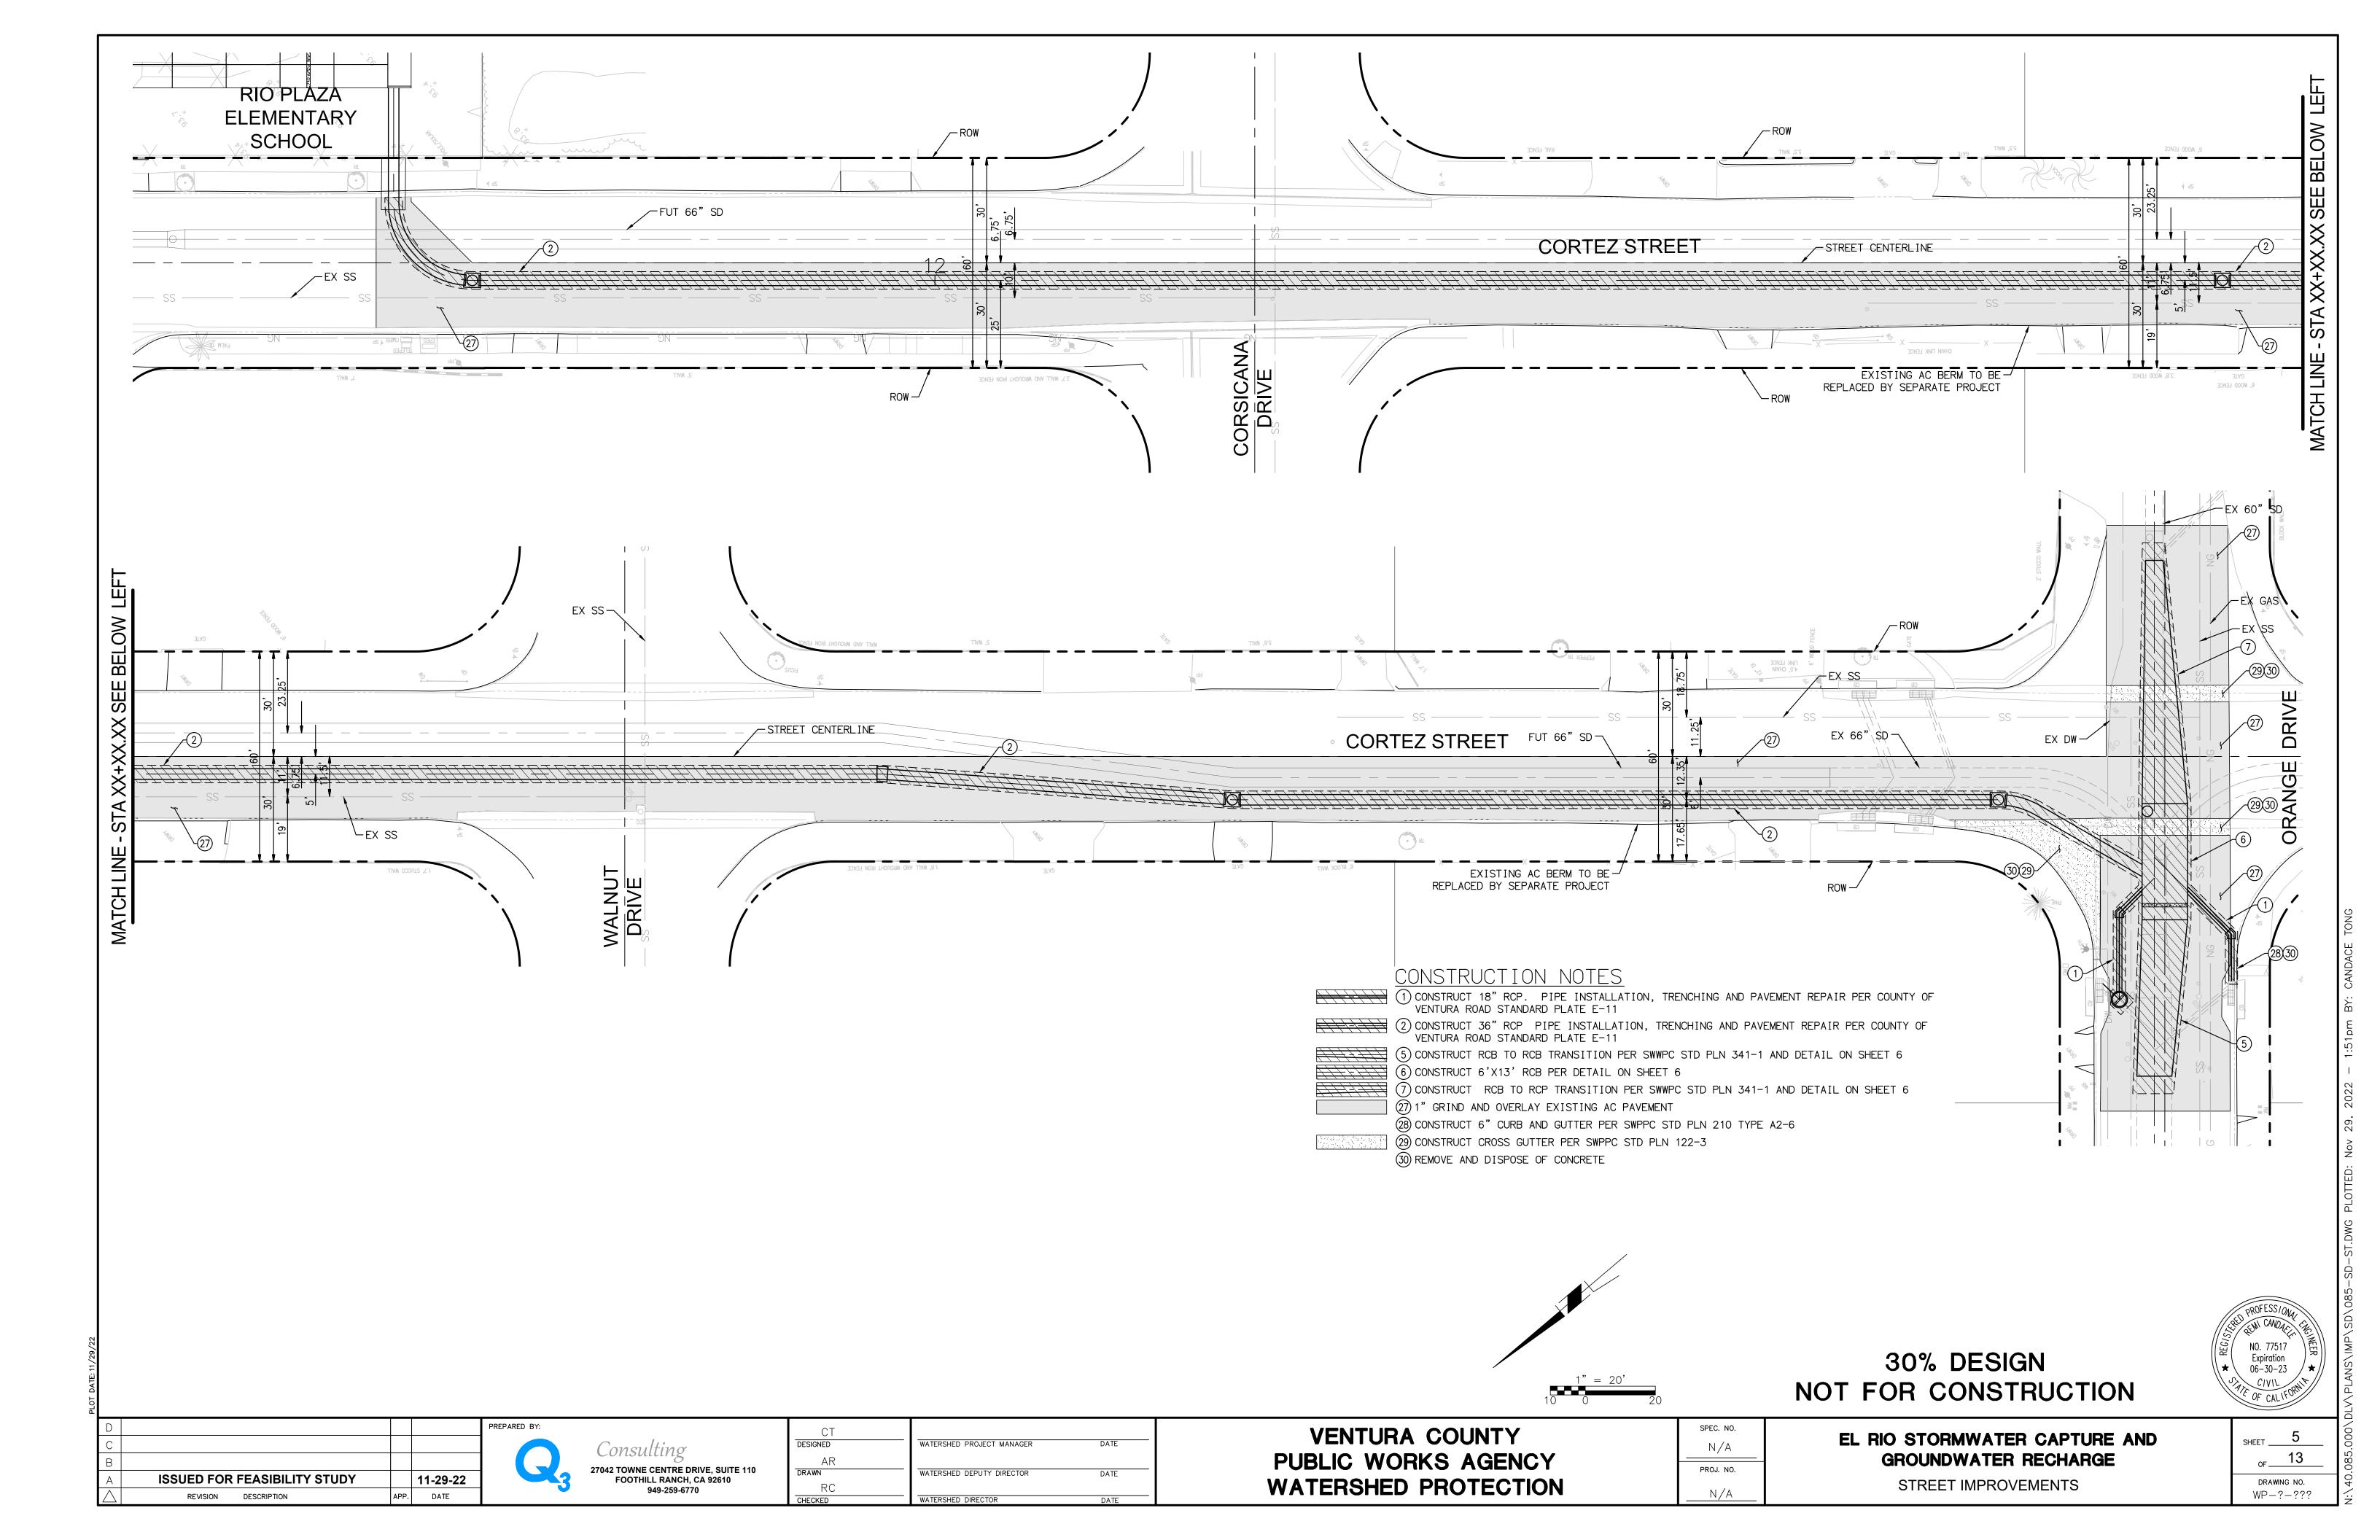
VENTURA COUNTY PUBLIC WORKS AGENCY WATERSHED PROTECTION SPEC. NO. N/A PROJ. NO. N/A


EL RIO STORMWATER CAPTURE AND **GROUNDWATER RECHARGE** INDEX AND CONSTRUCTION NOTES


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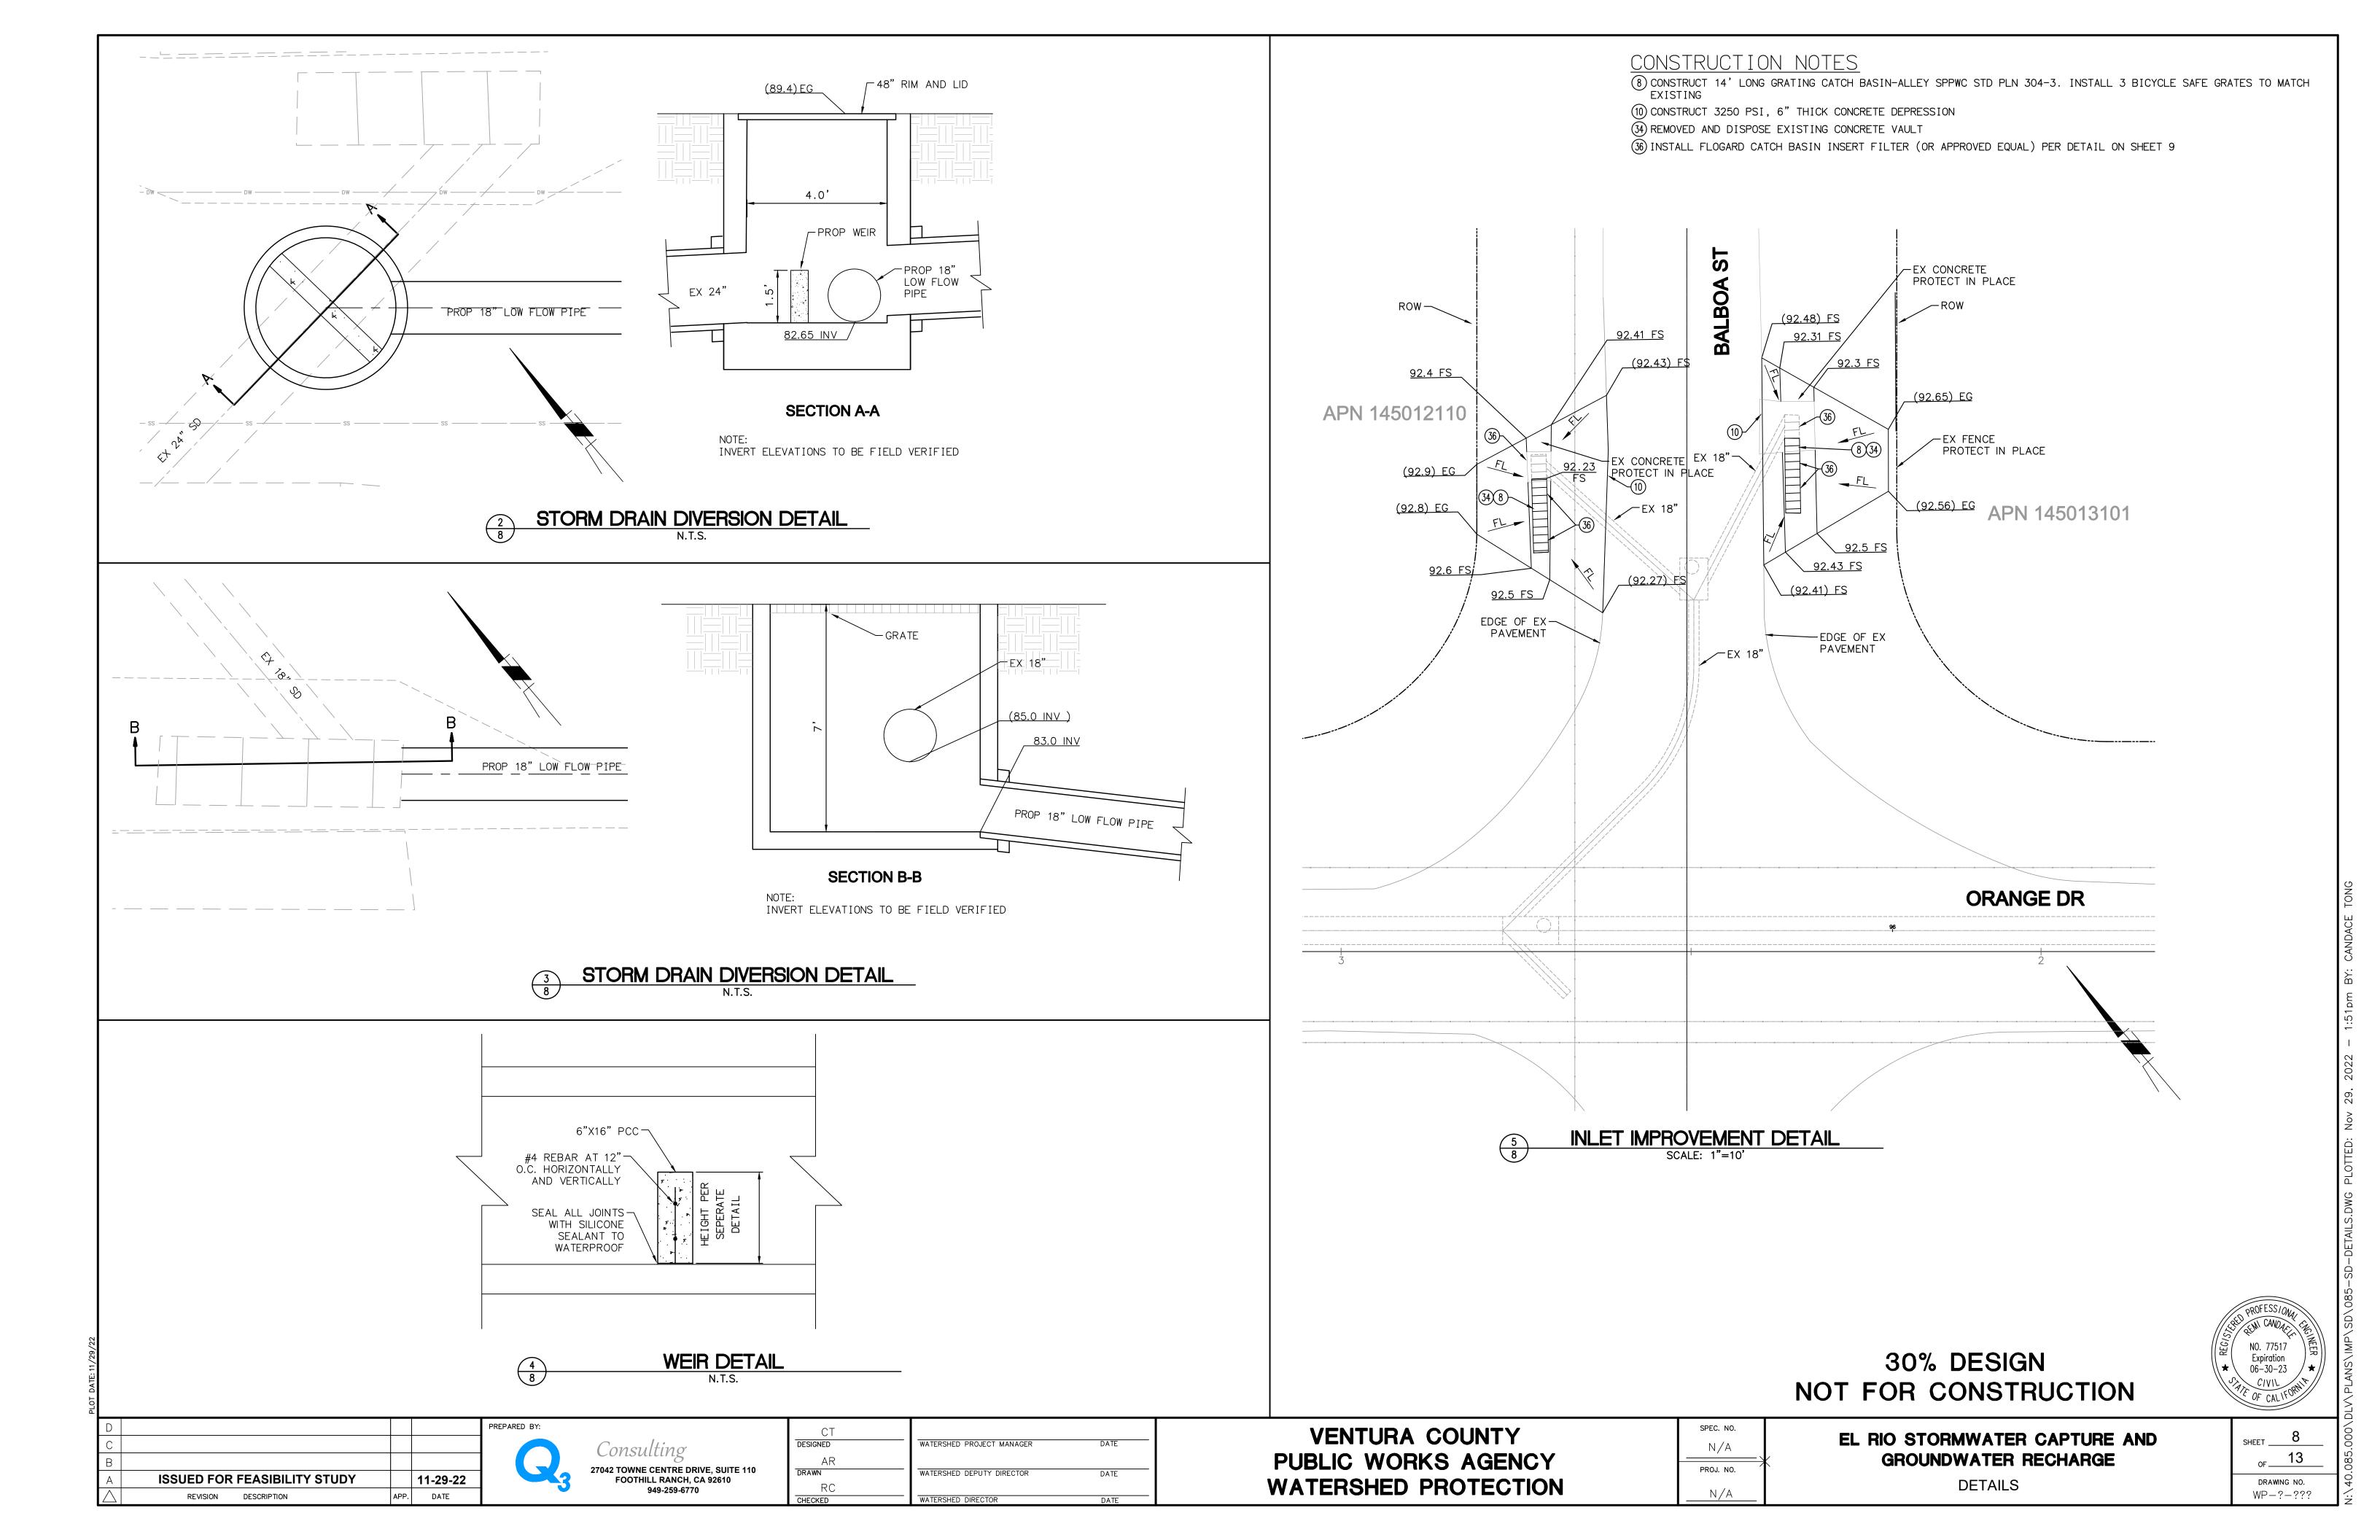





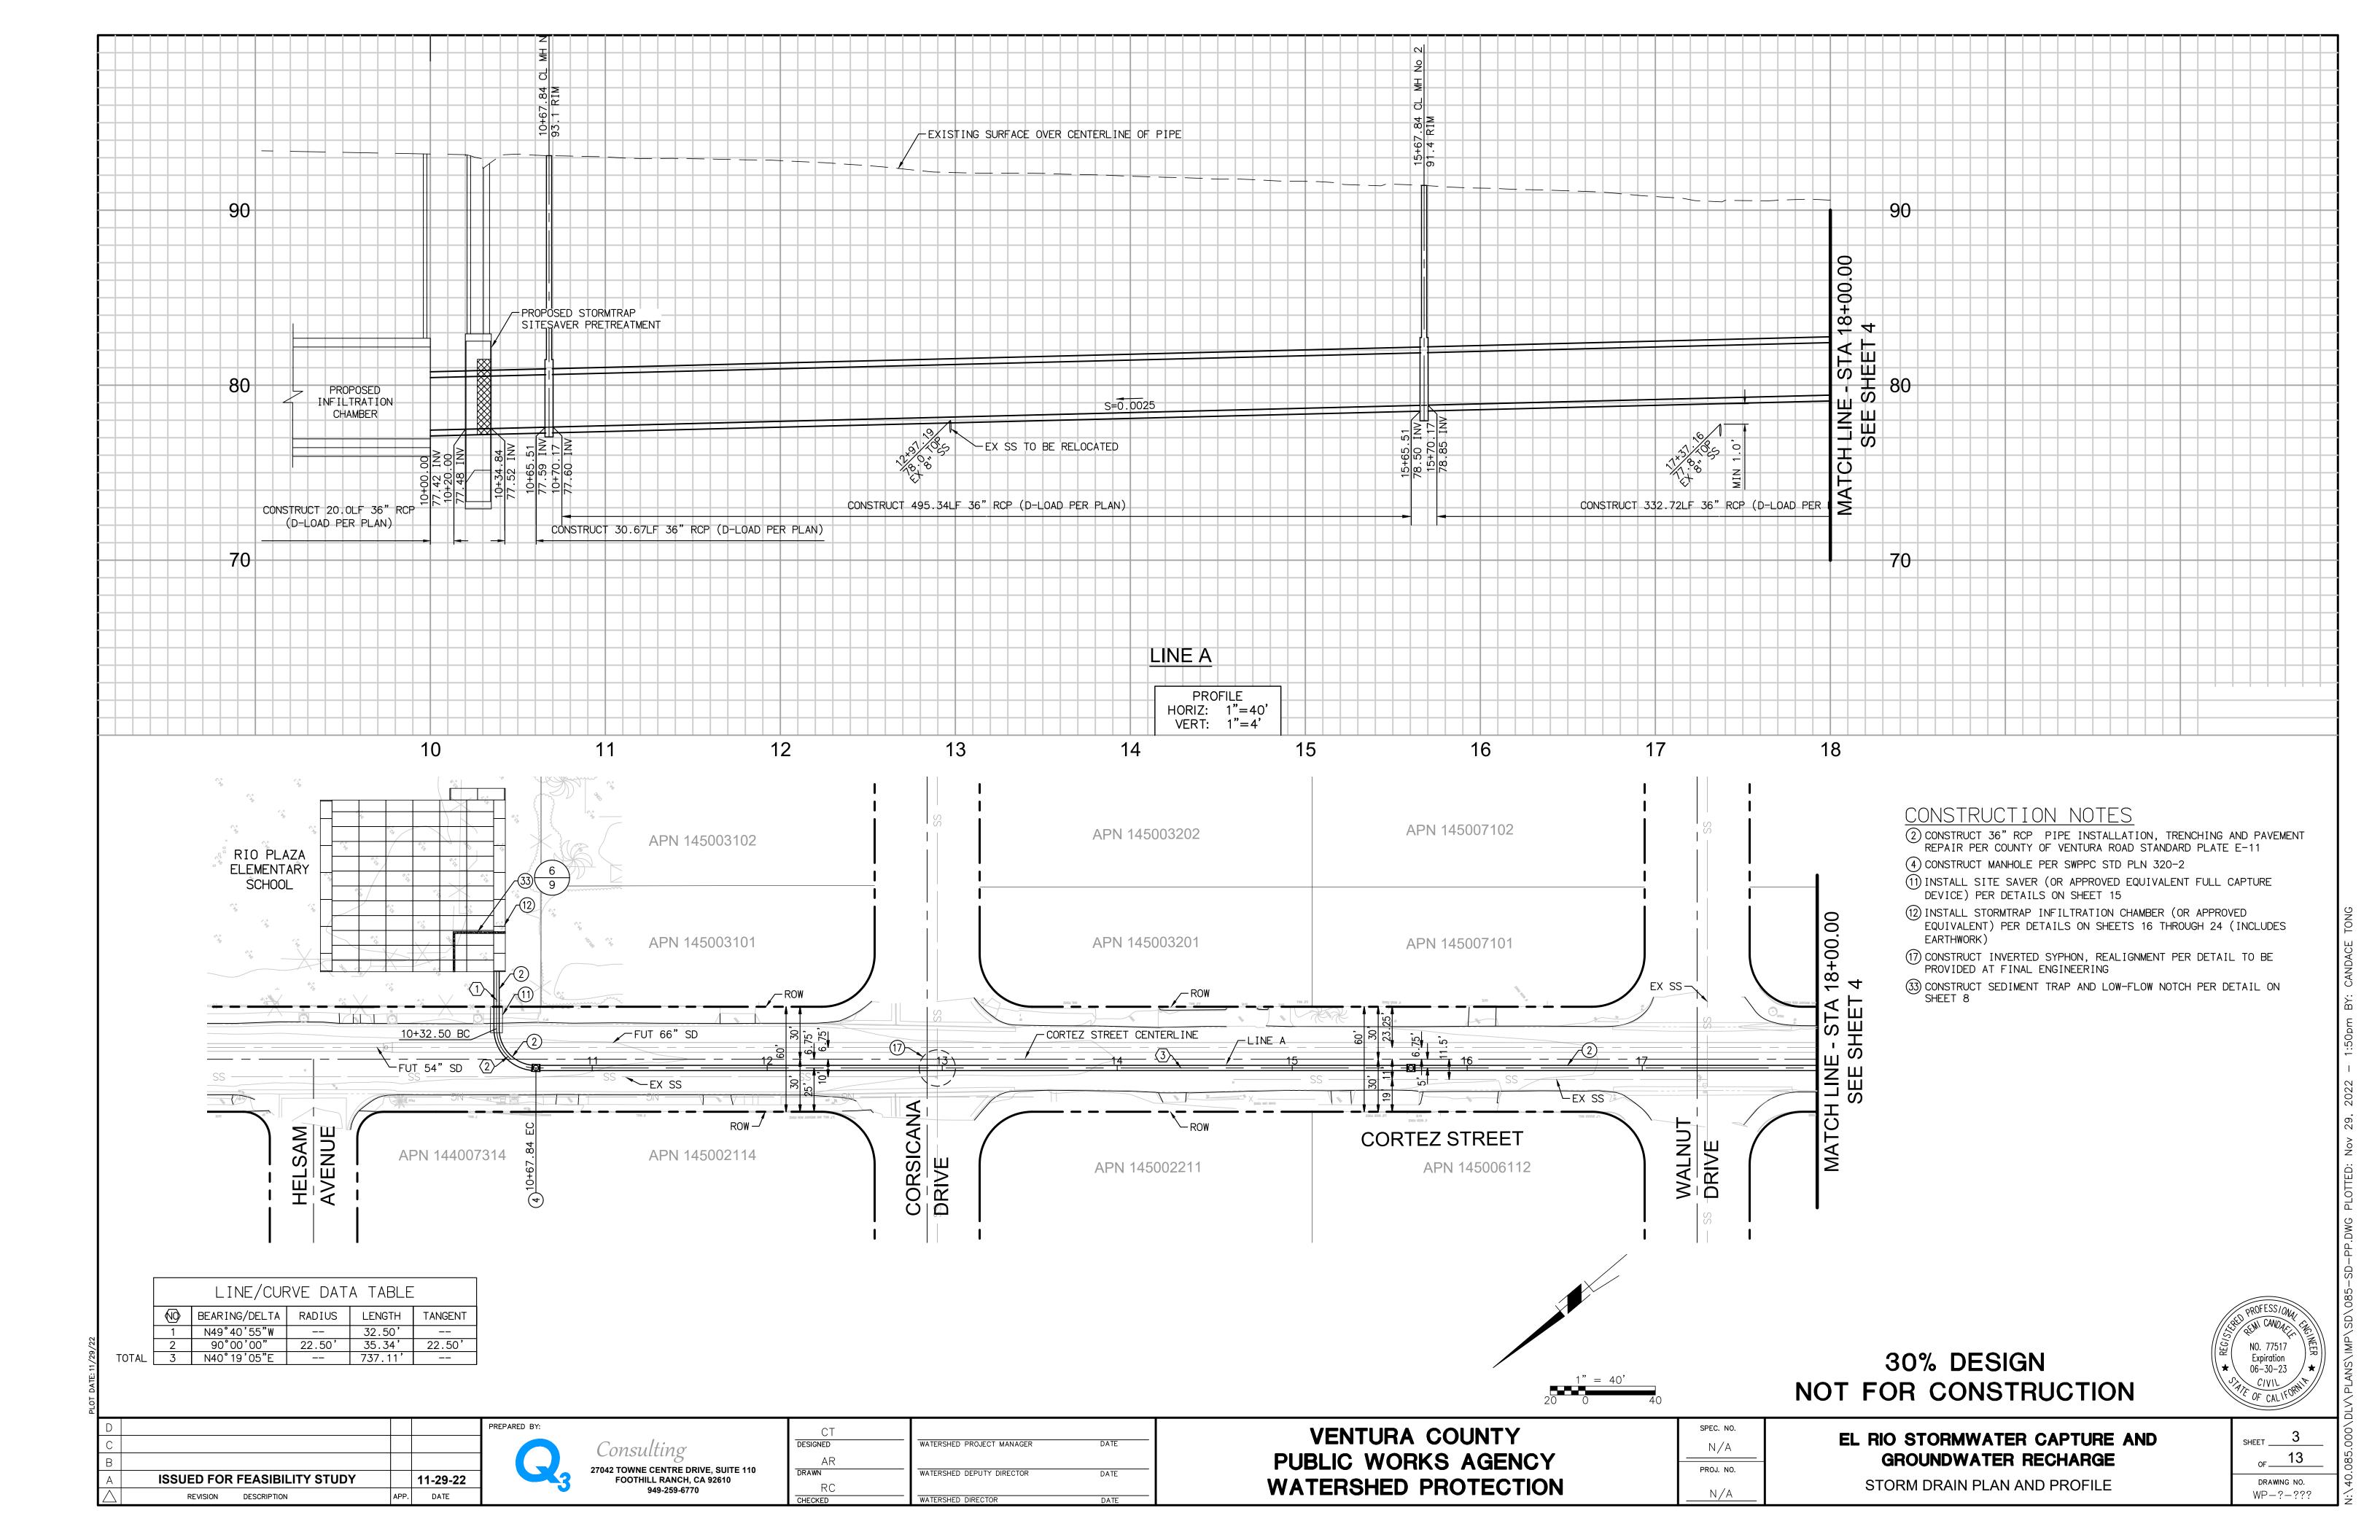

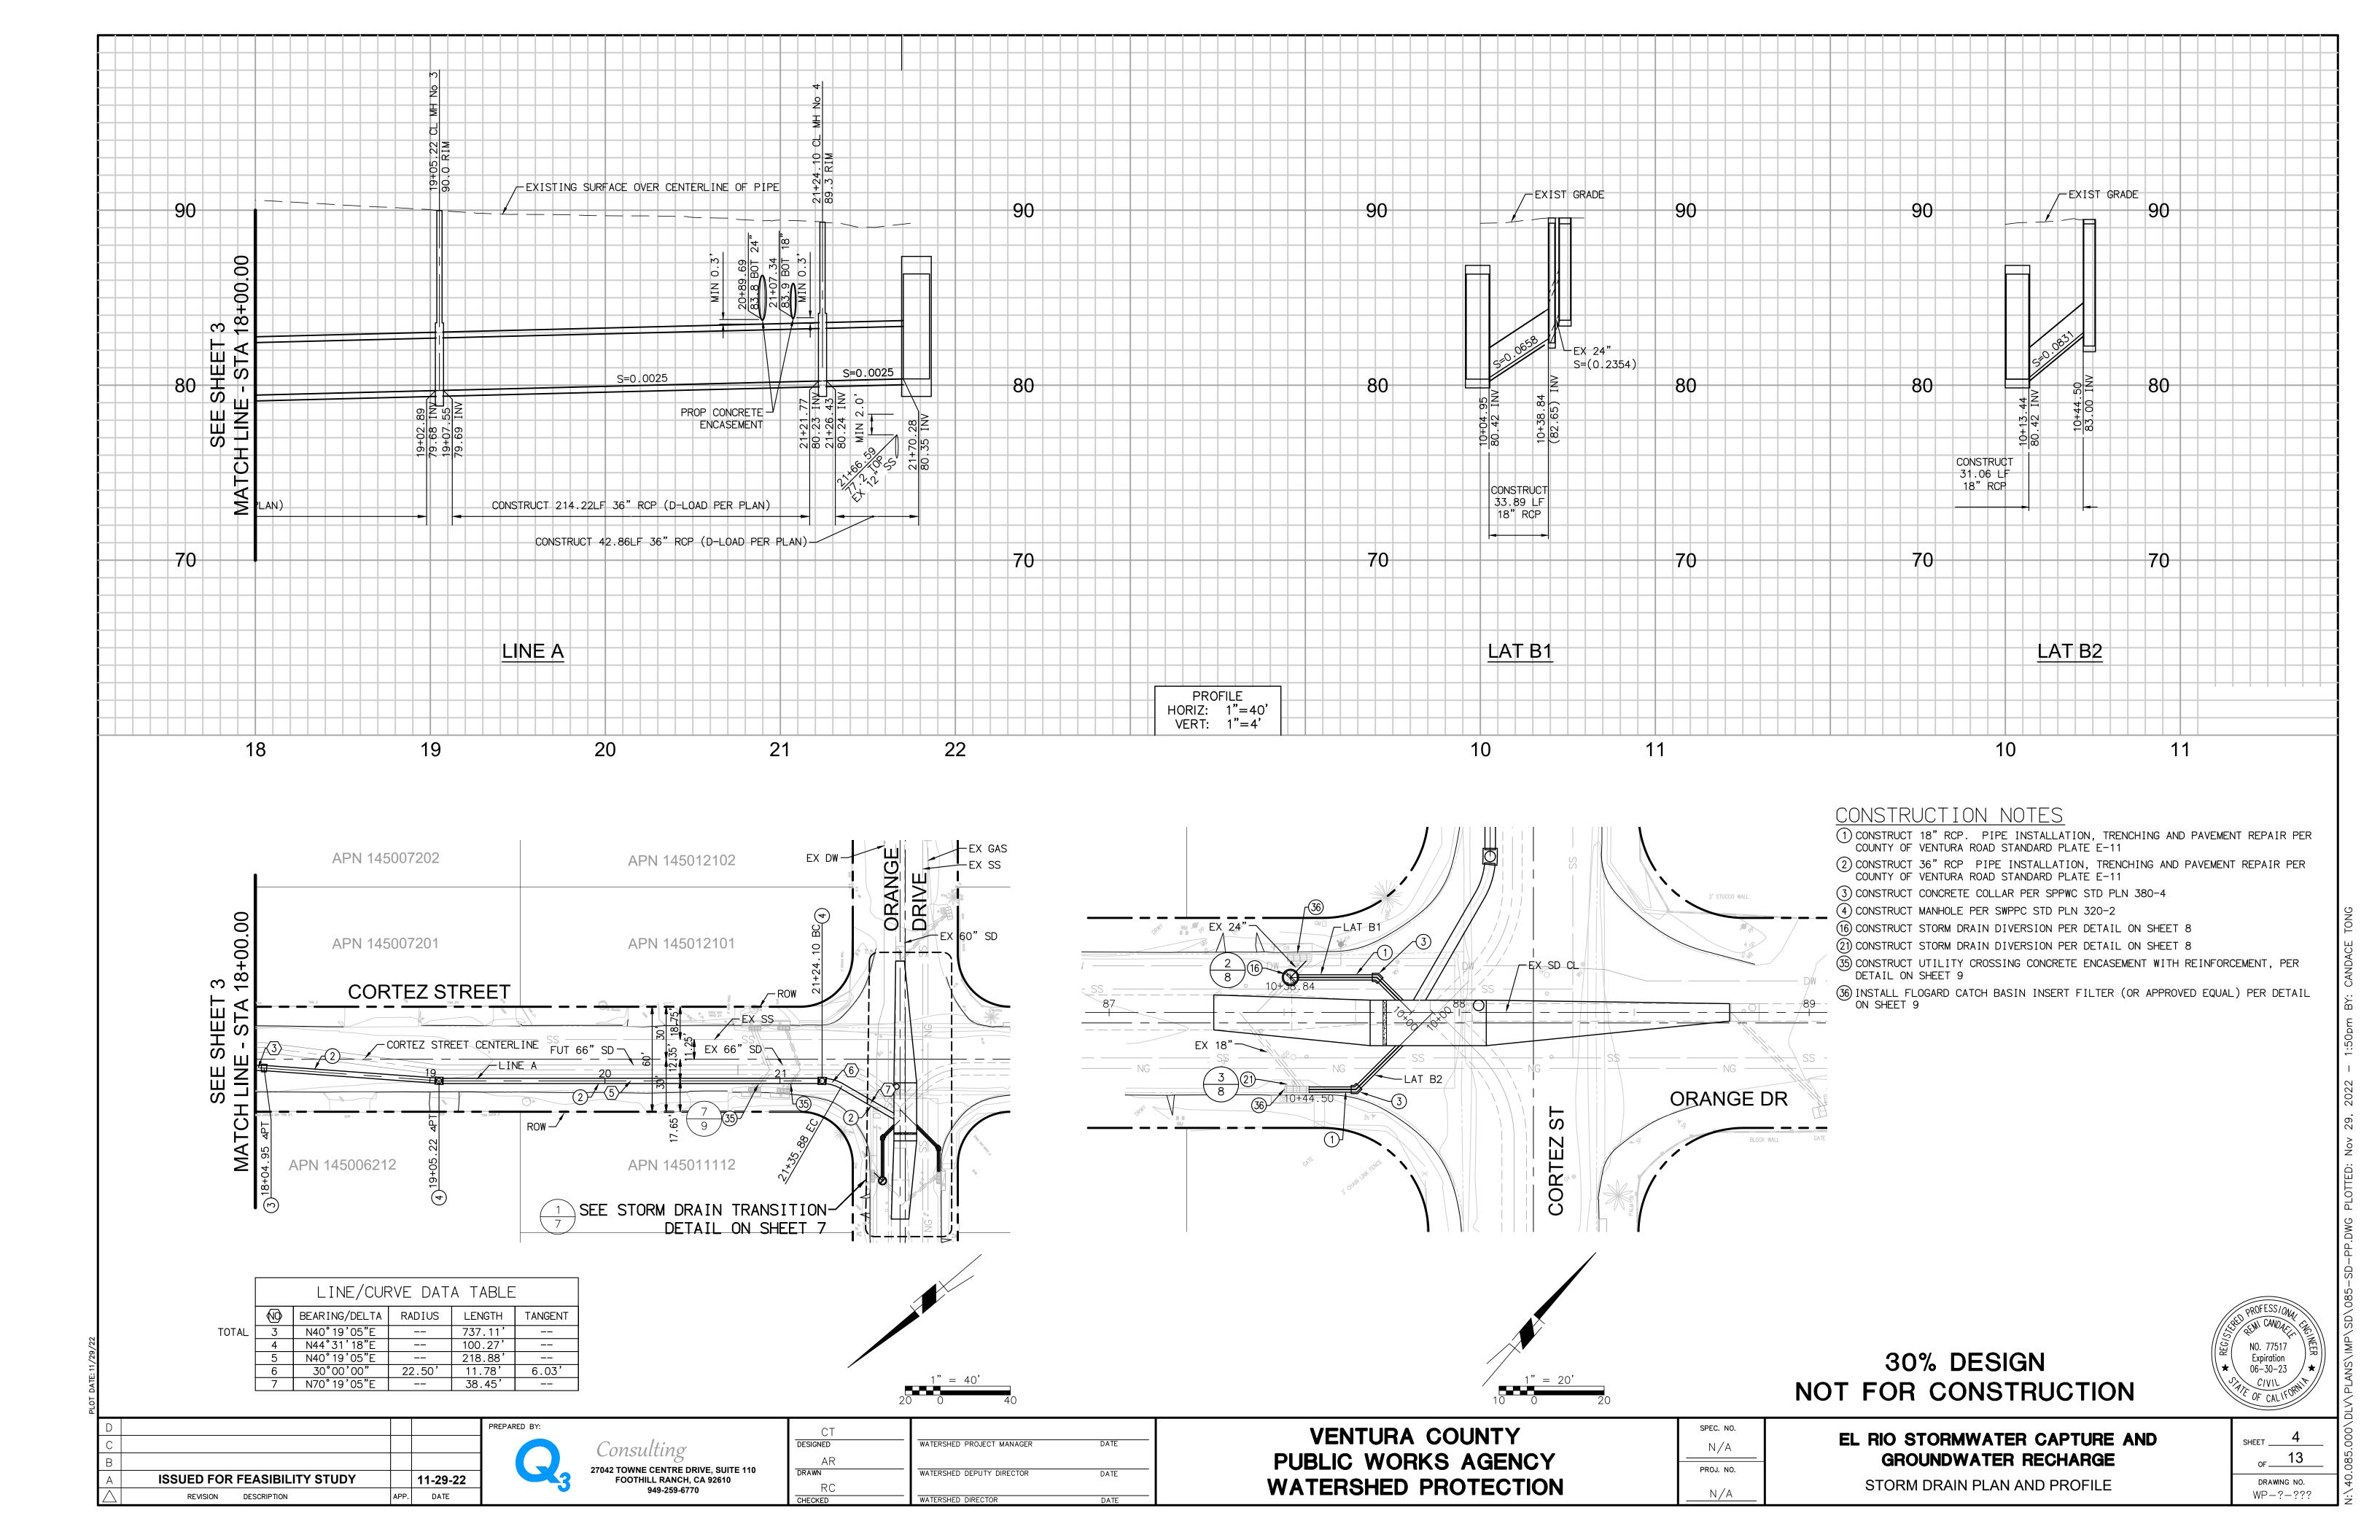


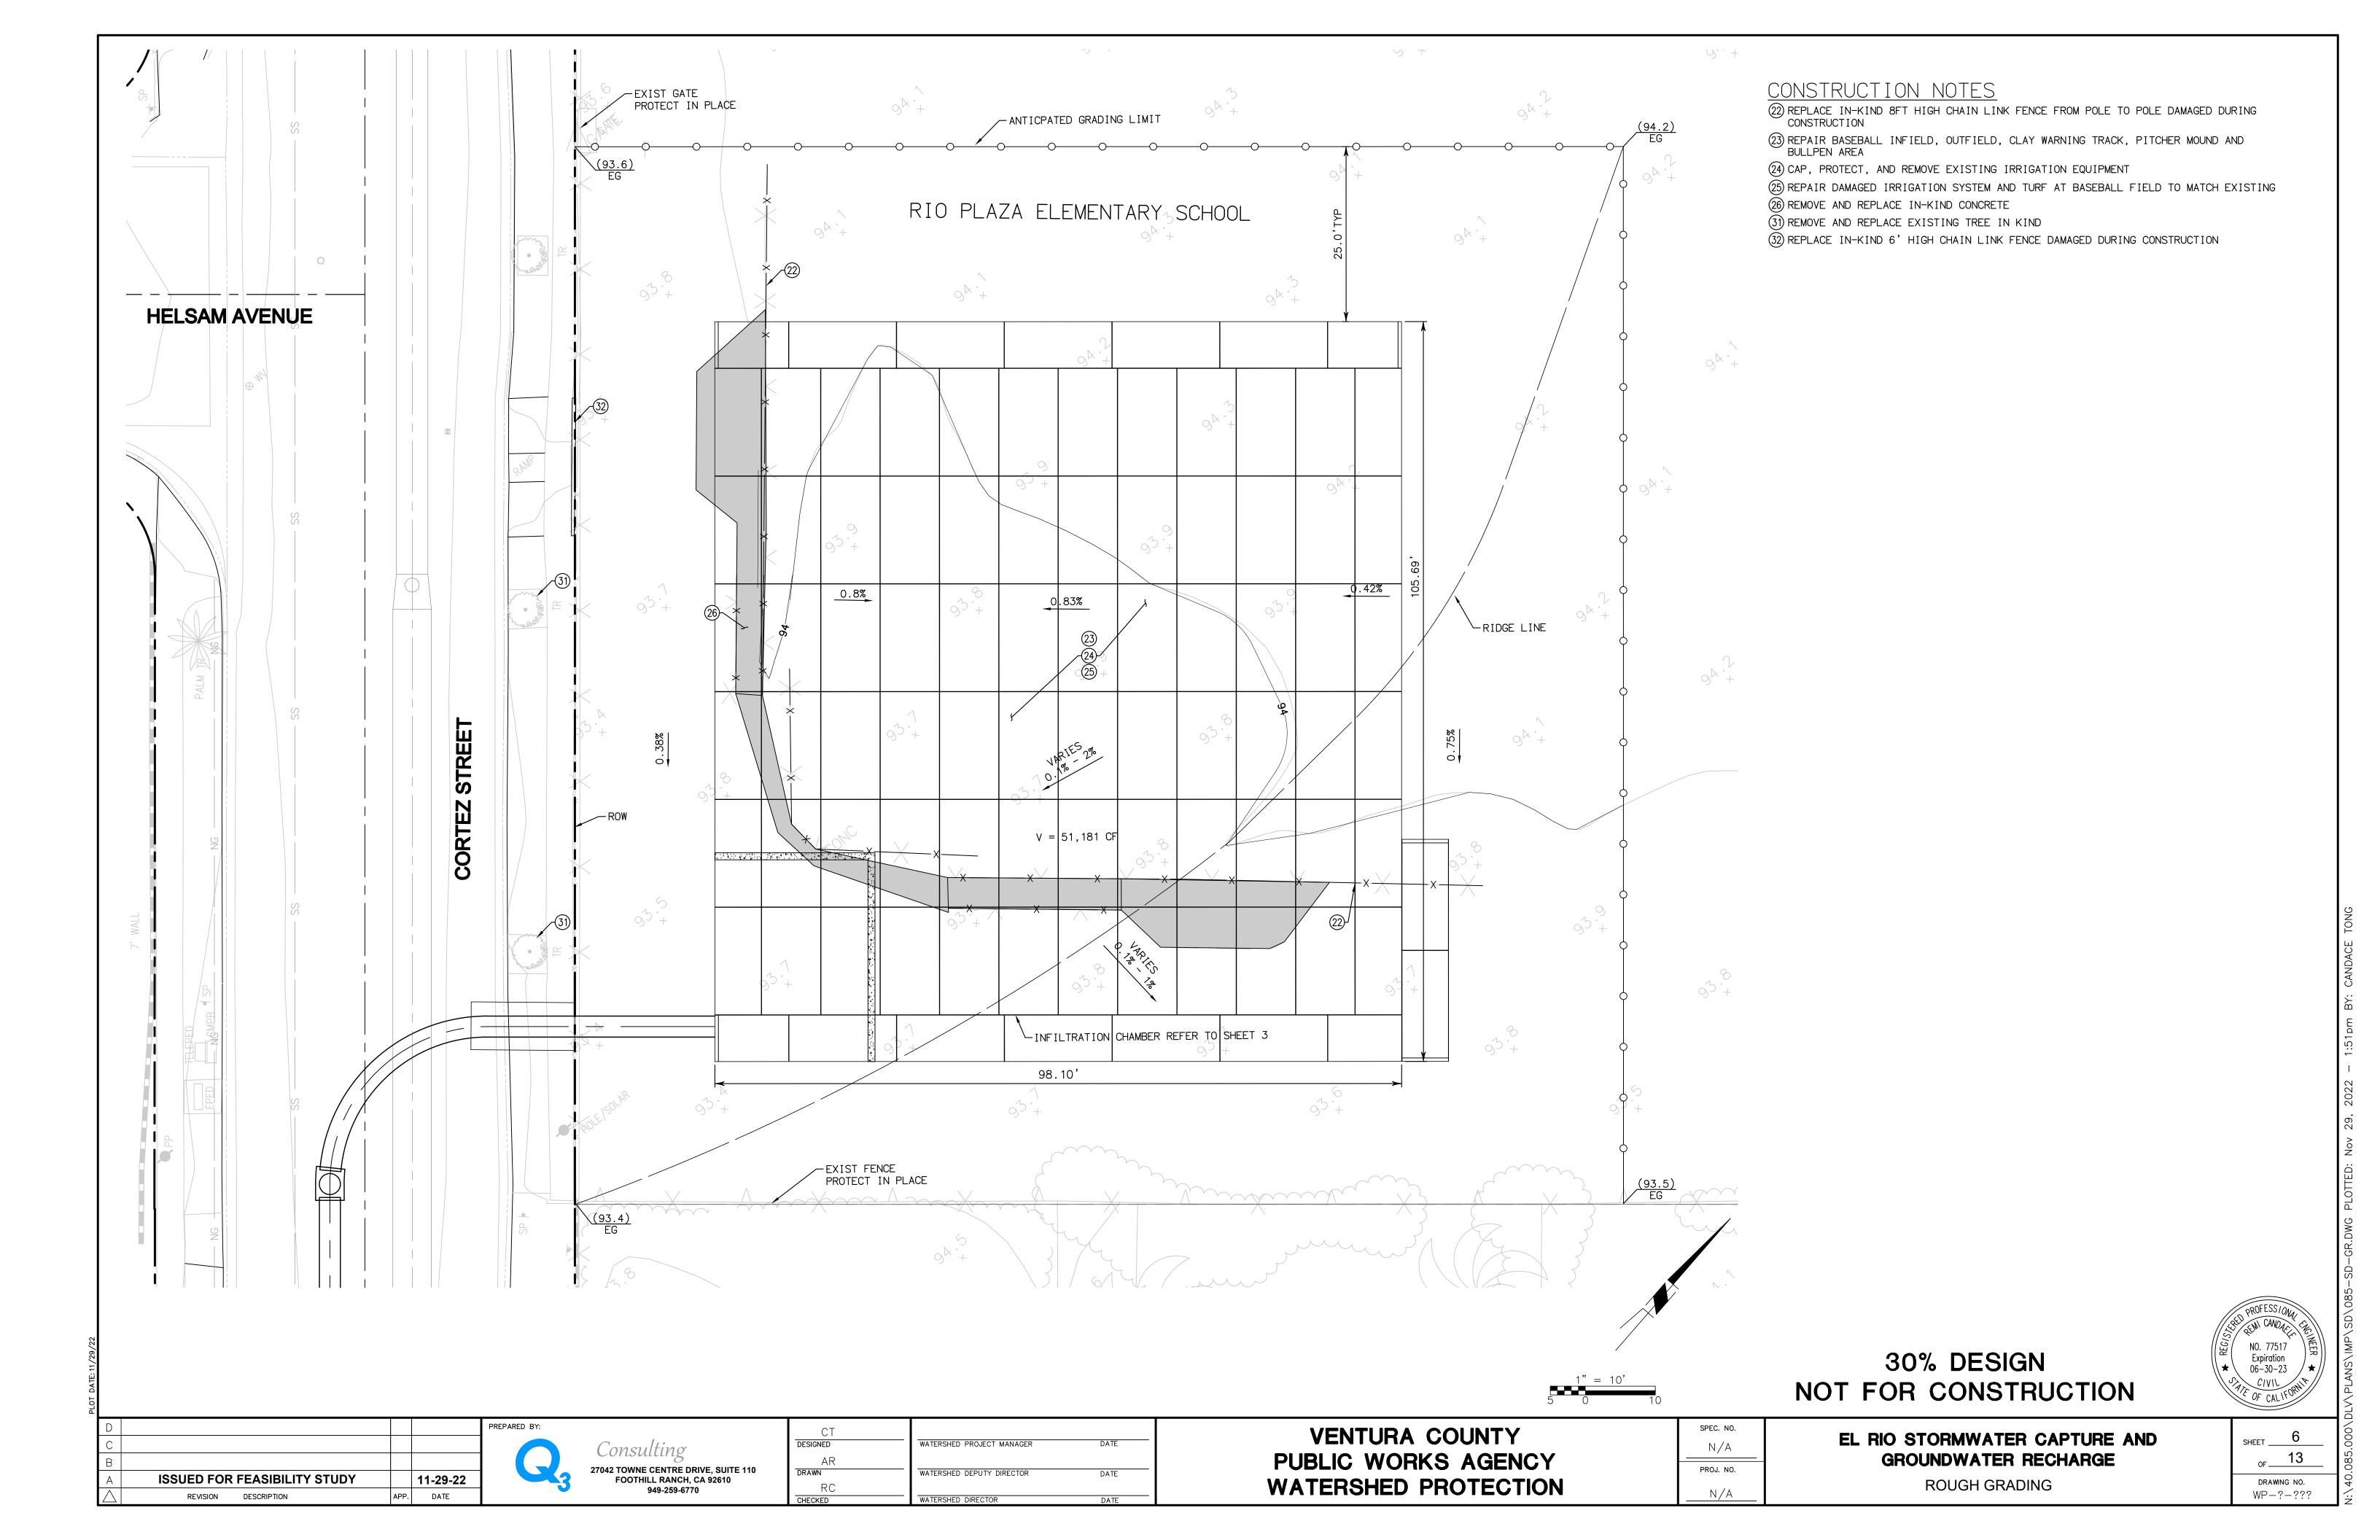

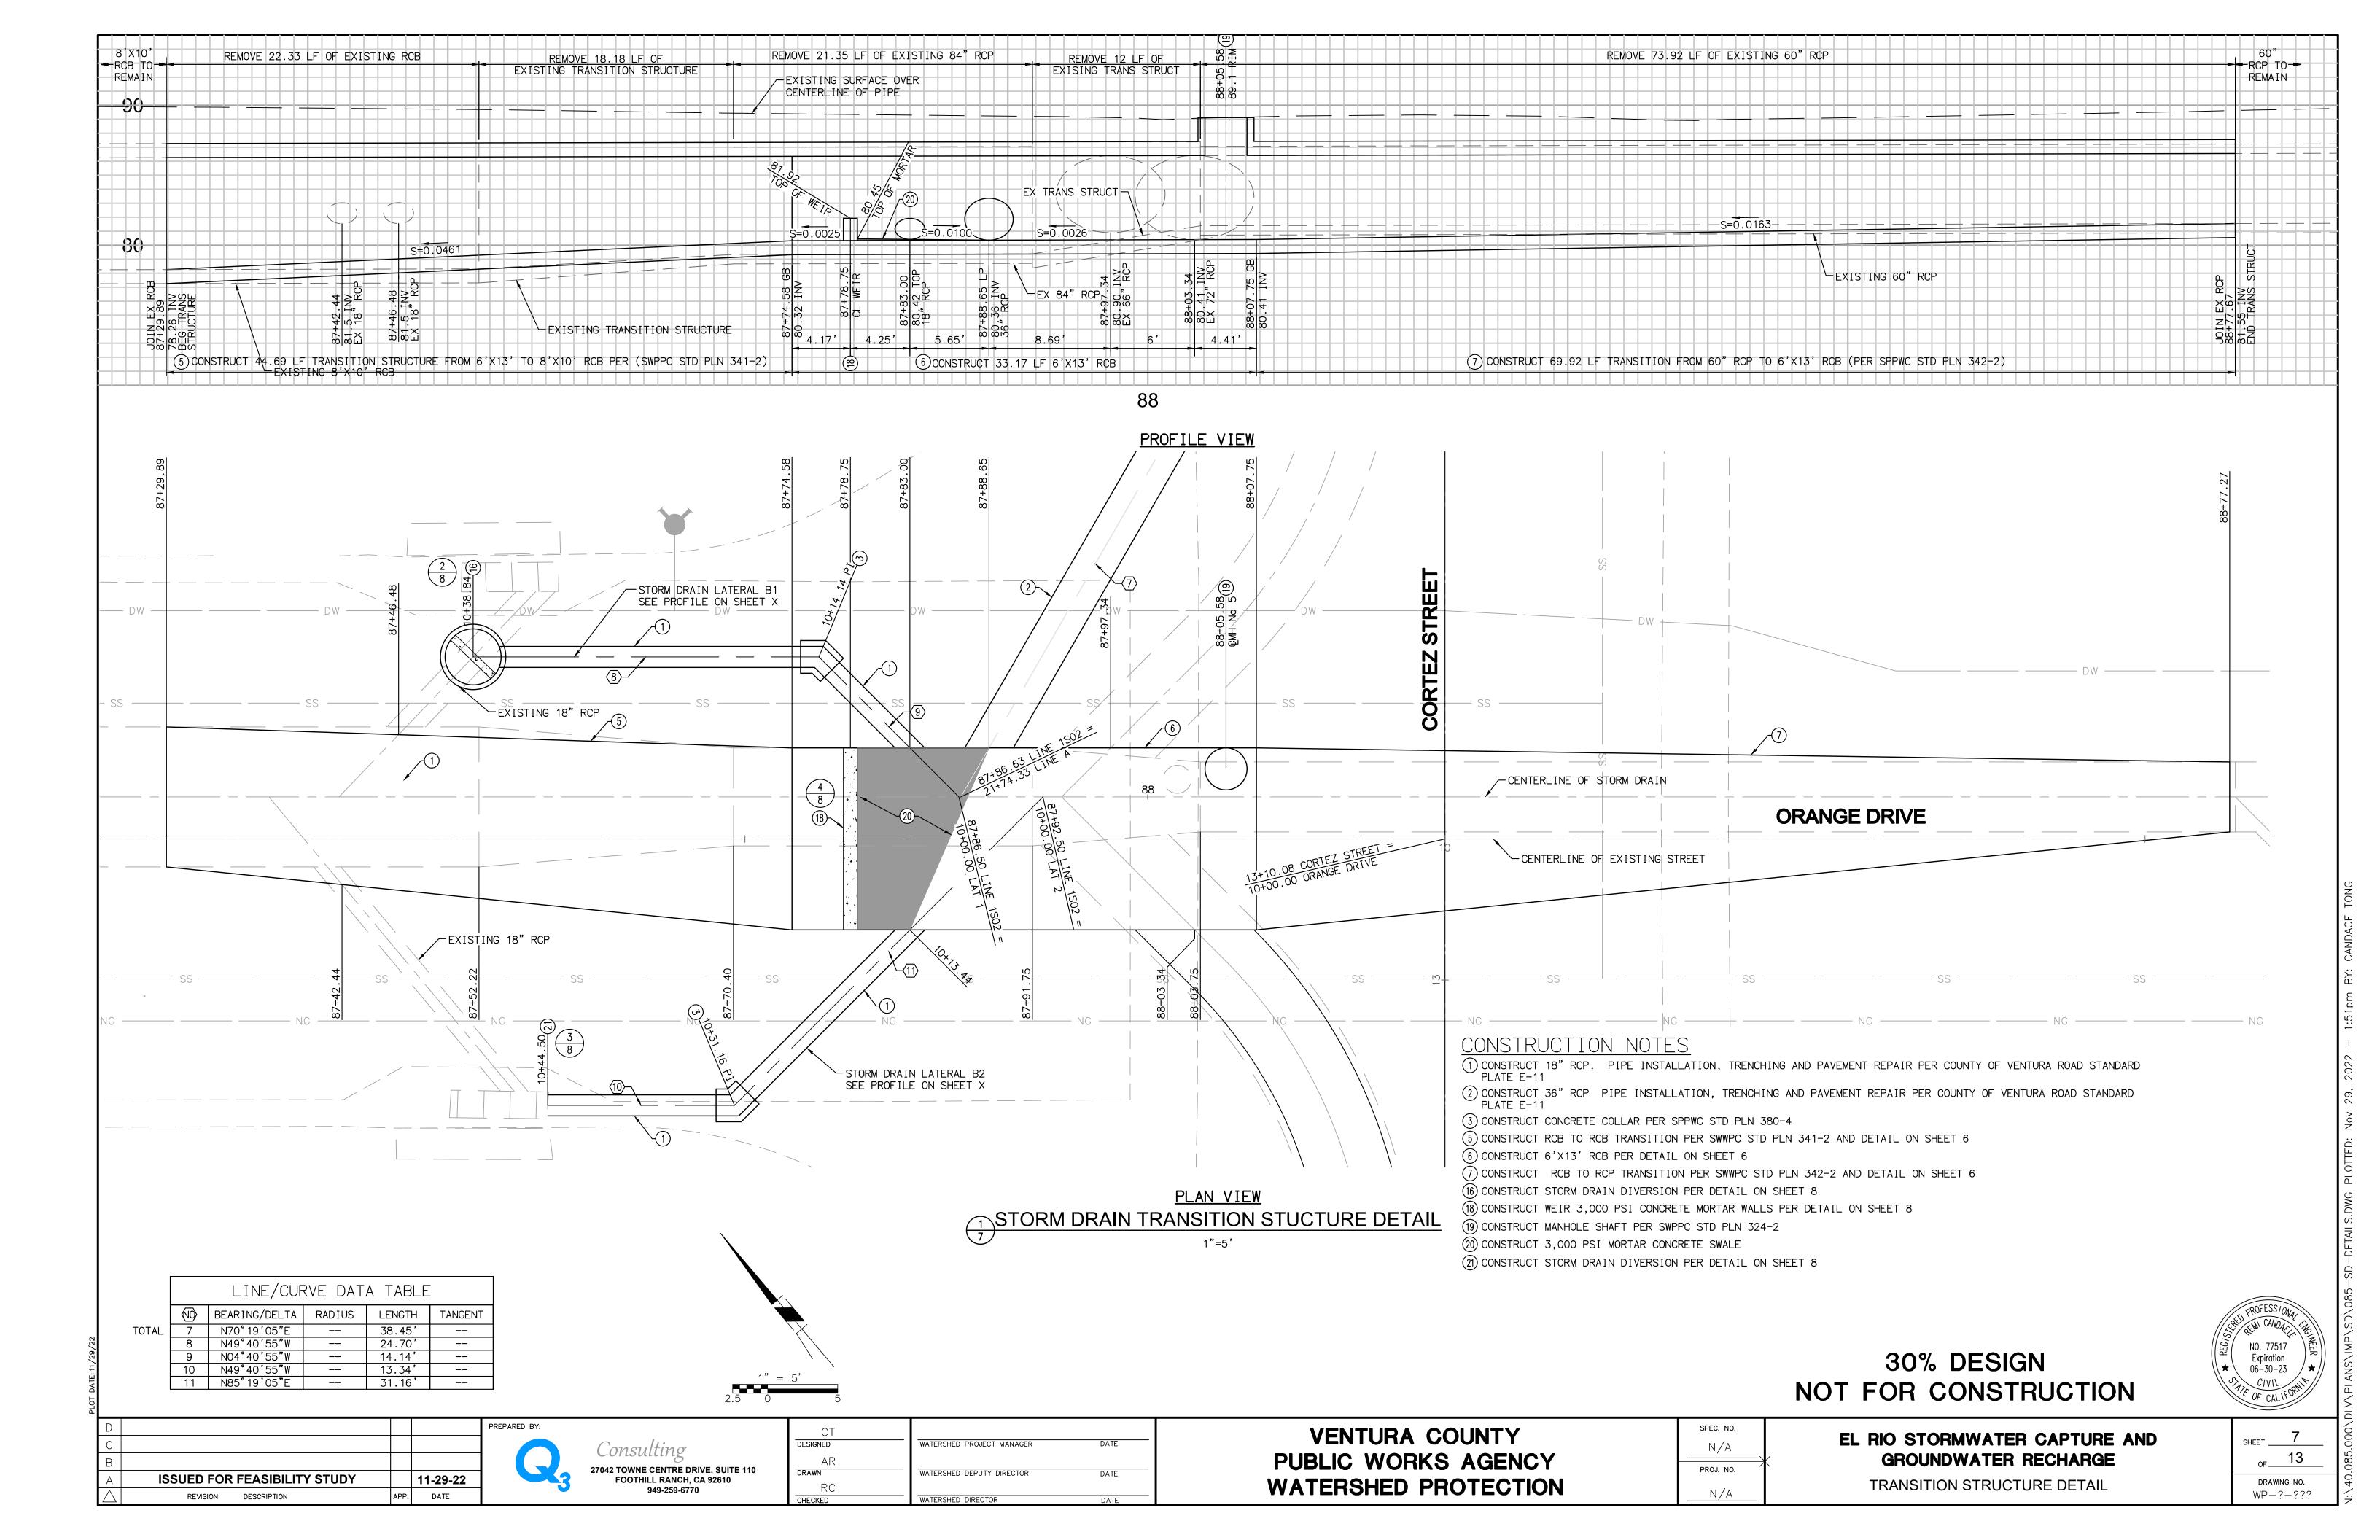


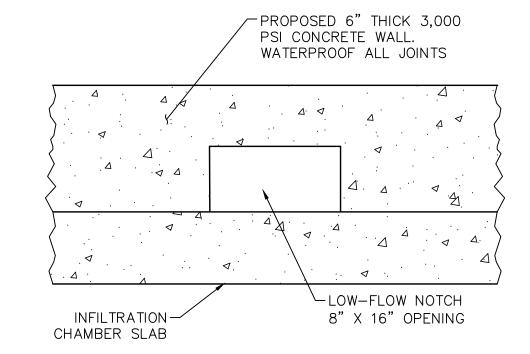

SEDIMENT WALL DETAIL

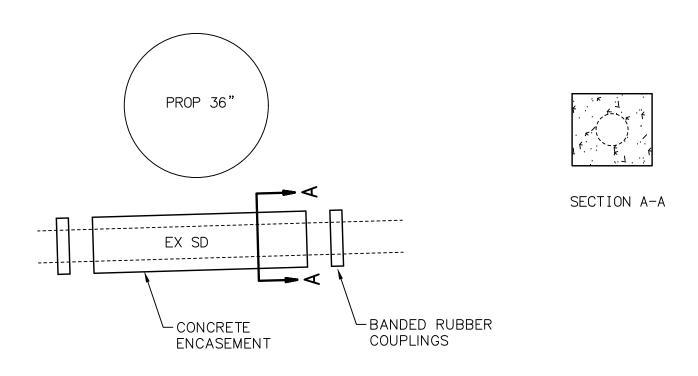



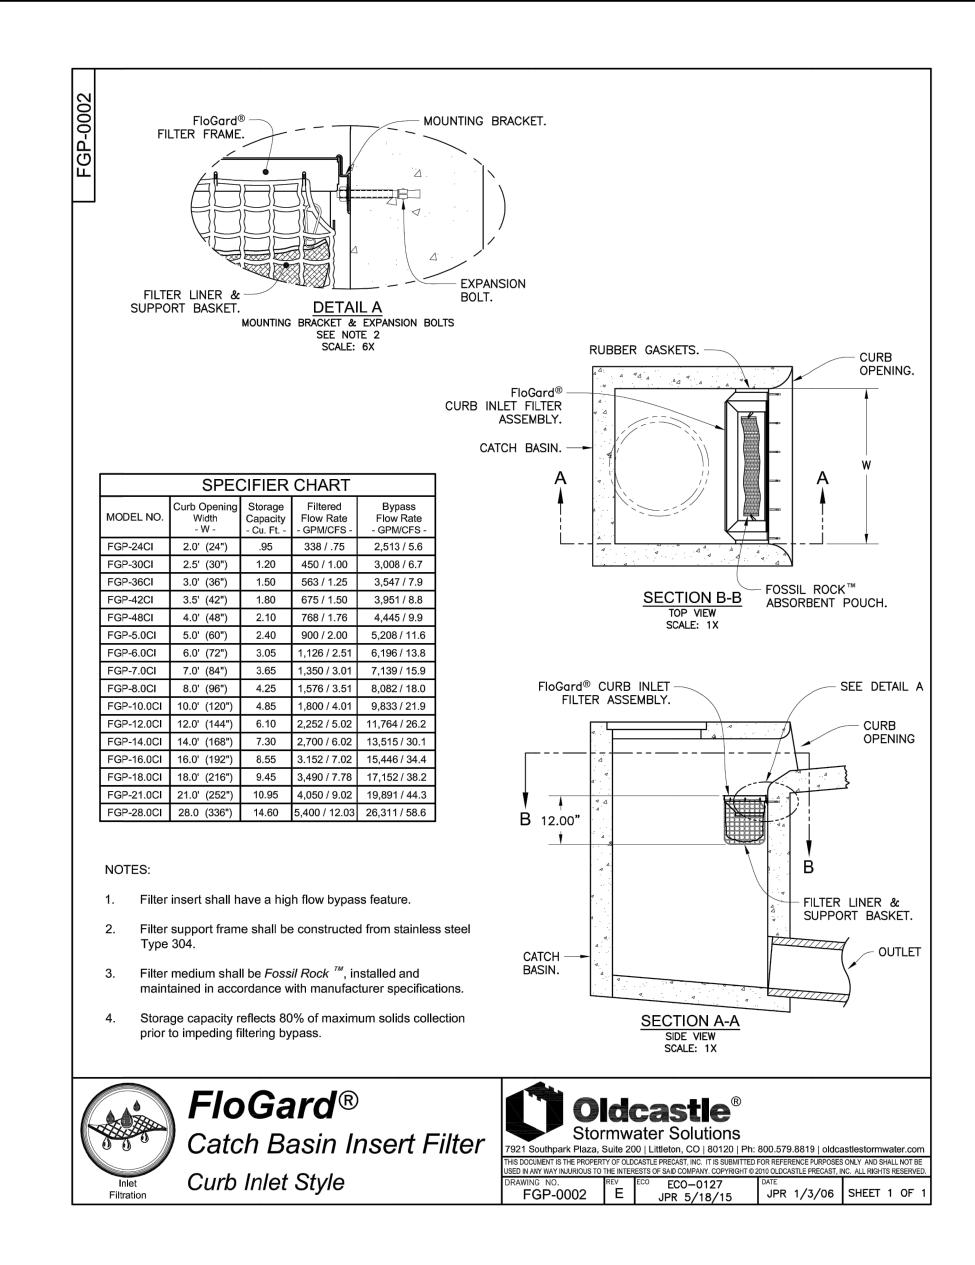



30% DESIGN NOT FOR CONSTRUCTION

EL RIO STORMWATER CAPTURE AND **GROUNDWATER RECHARGE**

NO. 77517 Expiration 06-30-23 SHEET 9 oF____13

DRAWING NO. WP-?-???

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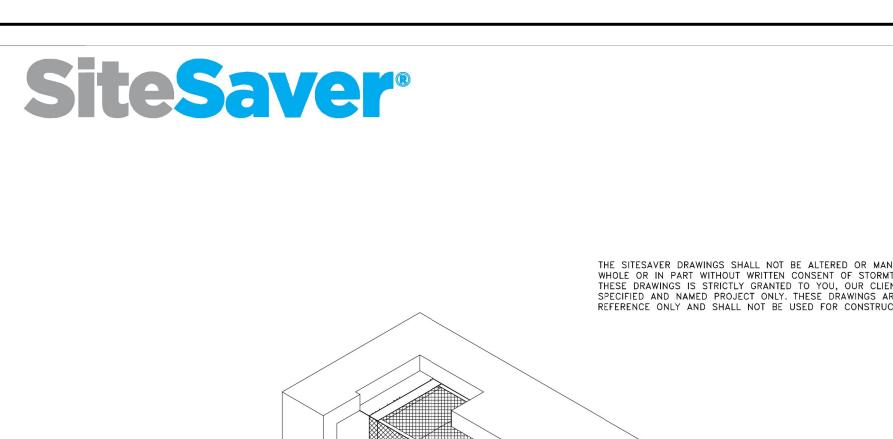
APP. DATE



CT DESIGNED	WATERSHED PROJECT MANAGER	DATE
AR Drawn	WATERSHED DEPUTY DIRECTOR	DATE
RC CHECKED	WATERSHED DIRECTOR	DATE

N/A

PROJ. NO.



THE SITESAVER DRAWINGS SHALL NOT BE ALTERED OR MANIPULATED IN WHOLE OR IN PART WITHOUT WRITTEN CONSENT OF STORMTRAP. USE OF THESE DRAWINGS IS STRICTLY GRANTED TO YOU, OUR CLIENT, FOR THE SPECIFIED AND NAMED PROJECT ONLY. THESE DRAWINGS ARE FOR YOUR REFERENCE ONLY AND SHALL NOT BE USED FOR CONSTRUCTION PURPOSES.

STORMTRAP CONTACT INFORMATION STORMTRAP SUPPLIER: STORMTRAP CONTACT NAME: John Shallahamer CELL PHONE: 415-405-6355 SALES EMAIL: jshallahamer@stormtrap.com

SITESAVER STSS-7

FIXED BASKET OPTION

SHEET INDEX

DESCRIPTION

PAGE

0.0 COVER SHEET

1.0 SITESAVER DESIGN CRITERIA

2.0 SITESAVER SYSTEM LAYOUT

1287 WNDHAM PARKWAY ROMEOVILLE, IL 60446 P:815-941-4549 / F:331-318-5347 ENGINEER INFORMATION: Q3 Consulting 27042 Towne Center Drive #110 Foothill Ranch, CA 92610 PROJECT INFORMATION:

Storm Trap

PATENTS LISTED AT: [HTTP://STORMTRAP.COM/PATENT]

El Rio Community El Rio, CA

CURRENT ISSUE DATE: ISSUED FOR:

Standard Drawings REV. DATE: ISSUED FOR: RY. SCALE:

NTS SHEET TITLE:

SHEET NUMBER:

SHEET NUMBER:

COVER SHEET

StormTrap

PATENTS LISTED AT: [HTTP://STORMTRAP.COM/PATENT]

STRUCTURAL DESIGN LOADING CRITERIA LIVE LOADING: AASHTO HS-20 HIGHWAY LOADING GROUND WATER TABLE: BELOW THE SYSTEM INVERT

SOIL DENSITY: 120 PCF

SOIL BEARING PRESSURE: 3000PSF

EQUIVALENT UNSATURATED LATERAL ACTIVE EARTH PRESSURE: 35 PSF / FT.

EQUIVALENT SATURATED

WATER QUALITY FLOW RATE: 7.00 CFS PEAK FLOW RATE: 39.80 CFS SEDIMENT STORAGE: - CuFt TRASH/DEBRIS STORAGE: - CuFt EFFECTIVE SETTLING AREA:

SEE SHEET 4.0 FOR BACKFILL SPECIFICATIONS

LATERAL ACTIVE EARTH PRESSURE: 80 PSF/FT. (IF WATER TABLE PRESENT) -System must be sized for 100% removal of a 125µ particle APPLICABLE CODES: ASTM C857 BACKFILL TYPE: SEE SHEET 4.0 FOR BACKFILL OPTIONS

at the Water Quality Flow Rate. -Fixed XL Basket must be sized to capture all particles 5mm

MIN. 3000 PSF BEARING CAPACITY TO BE VERIFIED IN FIELD BY OTHERS

10'-0" SITESAVER

SITESAVER SYSTEM INFORMATION

SITE SPECIFIC DESIGN CRITERIA

- 1. SITESAVER UNITS SHALL BE MANUFACTURED AND INSTALLED ACCORDING TO SHOP DRAWINGS APPROVED BY THE INSTALLING CONTRACTOR AND ENGINEER OF RECORD. THE SHOP DRAWINGS SHALL INDICATE SIZE AND LOCATION OF ROOF OPENINGS AND INLET/ OUTLET PIPE TYPES, SIZES, INVERT ELEVATIONS AND SIZE OF
- 2. COVER RANGE: MIN. 6" MAX. 16' CONSULT STORMTRAP FOR ADDITIONAL COVER OPTIONS.

10'-0" SITESAVER

6" STONE BASE

- 3. ALL DIMENSIONS AND SOIL CONDITIONS, INCLUDING BUT NOT LIMITED TO GROUNDWATER AND SOIL BEARING CAPACITY ARE REQUIRED TO BE VERIFIED IN THE FIELD BY OTHERS PRIOR TO SITESAVER INSTALLATION.
- 4. FOR STRUCTURAL CALCULATIONS THE GROUND WATER TABLE IS ASSUMED TO BE BELOW THE SYSTEM INVERT IF WATER TABLE IS DIFFERENT THAN ASSUMED, CONTACT STORMTRAP.
- 5. CONTRACTOR TO ENSURE FRAMES AND COVER CLEARS THE OPENING DIMENSIONS AND MEETS ALL LOAD RATINGS.
- 6. SYSTEM DESIGN INTENT IS TO CONTAIN WATER AND / OR PREVENT GROUNDWATER MIGRATION INTO THE SYSTEM AND WILL NOT BE SUBJECT TO LEAKAGE TESTING. SOLUTION TO BE INSTALLED BY CONTRACTOR IN ACCORDANCE WITH THIRD PARTY WATER-PROOFING SUPPLIER'S PRODUCT SPECIFICATIONS.

El Rio Community El Rio, CA CURRENT ISSUE DATE: 8/22/22 SSUED FOR: Standard Drawings REV. DATE: ISSUED FOR: DWN.

StormTrap

PATENTS LISTED AT: [HTTP://STORMTRAP.COM/PATENT]

1287 WINDHAM PARKWAY ROMEOVILLE, IL 60446

P:815-941-4549 / F:331-318-5347

ENGINEER INFORMATION:

Q3 Consulting

27042 Towne Center Drive #110 Foothill Ranch, CA 92610

PROJECT INFORMATION:

SCALE: NTS

SHEET TITLE:

SITESAVER DESIGN CRITERIA

SHEET NUMBER:

BILL OF MATERIALS ITEM QTY WEIGHT (lbs) SITESAVER TOP MODULE 21,618 20,623 SITESAVER BASE MODULE 3 1 42" X 42" HATCH & RISER (SUPPLIED BY OTHERS) 4 1 Ø24" MANHOLE FRAME, COVER & RISER (SUPPLIED BY OTHERS) N/A SITESAVER STSS7 INSERT WATERSTOP ROLLS N/A INSTALLATION HARDWARE KIT N/A

LOADING DISCLAIMER:

SITESAVER IS NOT DESIGNED TO ACCEPT ANY ADDITIONAL LOADINGS FROM NEARBY STRUCTURES NEXT TO OR OVER THE TOP OF STORMTRAP. IF ADDITIONAL LOADING CONSIDERATIONS ARE REQUIRED FOR STRUCTURAL DESIGN OF SITESAVER, PLEASE CONTACT STORMTRAP IMMEDIATELY.

El Rio Community


El Rio, CA

TREE LOADING DISCLAIMER:

THE SITESAVER SYSTEM HAS NOT BEEN DESIGNED TO SUPPORT THE ADDITIONAL WEIGHT OF ANY TREES. FURTHERMORE, THE ROOTS OF THE TREES MUST BE CONTAINED TO PREVENT FUTURE DAMAGE TO THE SITESAVER SYSTEM. STORMTRAP ACCEPTS NO LIABILITY FOR DAMAGES CAUSED BY TREES OR OTHER VEGETATION PLACE AROUND OR ON TOP OF THE SYSTEM.

BUILDING PROXIMITY LOADING DISCLAIMER:

THESE DRAWINGS ARE NOT TO BE USED FOR BIDDING OR CONSTRUCTION PURPOSES. THIS DESIGN ASSUMES THAT NO VERTICAL LOADS, SURCHARGE LOADS, OR DIRECT LATERAL LOADS
ARE EXERTED ON THE SITESAVER SYSTEM BY BUILDING SUPERSTRUCTURES OR FOUNDATION ELEMENTS LOCATED IN PROXIMITY TO THE SITESAVER SYSTEM. THESE DRAWINGS ARE GENERIC AND DO NOT ACCOUNT FOR SPECIAL CONSIDERATIONS — BE THEY STRUCTURAL OR OTHERWISE — ASSOCIATED WITH ANY BUILDING STRUCTURE OR COMPONENTS. FURTHERMORE, AT THE TIME THESE DRAWINGS WERE PRODUCED, STORMTRAP DID NOT HAVE ACCESS TO STRUCTURAL OR FOUNDATION PLANS FOR THE PROPOSED BUILDING(S) LOCATED ON-SITE. STORMTRAP REQUESTS THE OPPORTUNITY TO REVIEW SAID PLANS AND RELEVANT DRAWINGS WHEN THEY ARE MADE AVAILABLE. STORMTRAP RESERVES THE RIGHT TO MODIFY THE DESIGN SHOWN HERE TO ADDRESS ANY ISSUES ASSOCIATED WITH THE SYSTEM'S PROXIMITY TO ANY BUILDING STRUCTURE

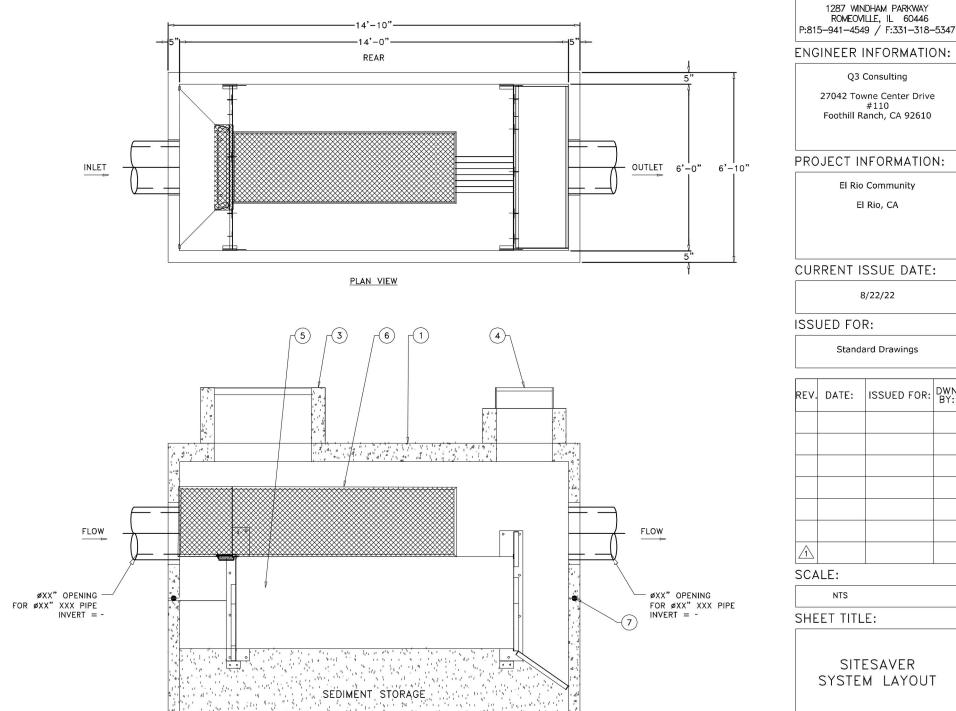

ELEVATION VIEW

CURRENT ISSUE DATE: Standard Drawings REV. DATE: ISSUED FOR: BY.

NOTES:

1. DIMENSIONING OF SITESAVER SYSTEM SHOWN BELOW ALLOW FOR A 1/4" GAP FOR METAL COMPONENTS.

- 2. ALL DIMENSIONS TO BE VERIFIED IN THE FIELD BY OTHERS.
- 3. SEE SHEET 3.0 FOR INSTALLATION SPECIFICATIONS.
- 4. INSTALLING CONTRACTORS RESPONSIBILITY TO ENSURE CONSISTENCY/ACCURACY TO FINAL ENGINEER OF RECORD PLAN SET.

PRETREATMENT DETAILS OR APPROVED EQUIVALENT

30% DESIGN NOT FOR CONSTRUCTION

EL RIO STORMWATER CAPTURE AND **GROUNDWATER RECHARGE**

OF CHE
10
SHEET
OF
DRAWING NO.

WP-?-???

NO. 77517

Expiration 06-30-23

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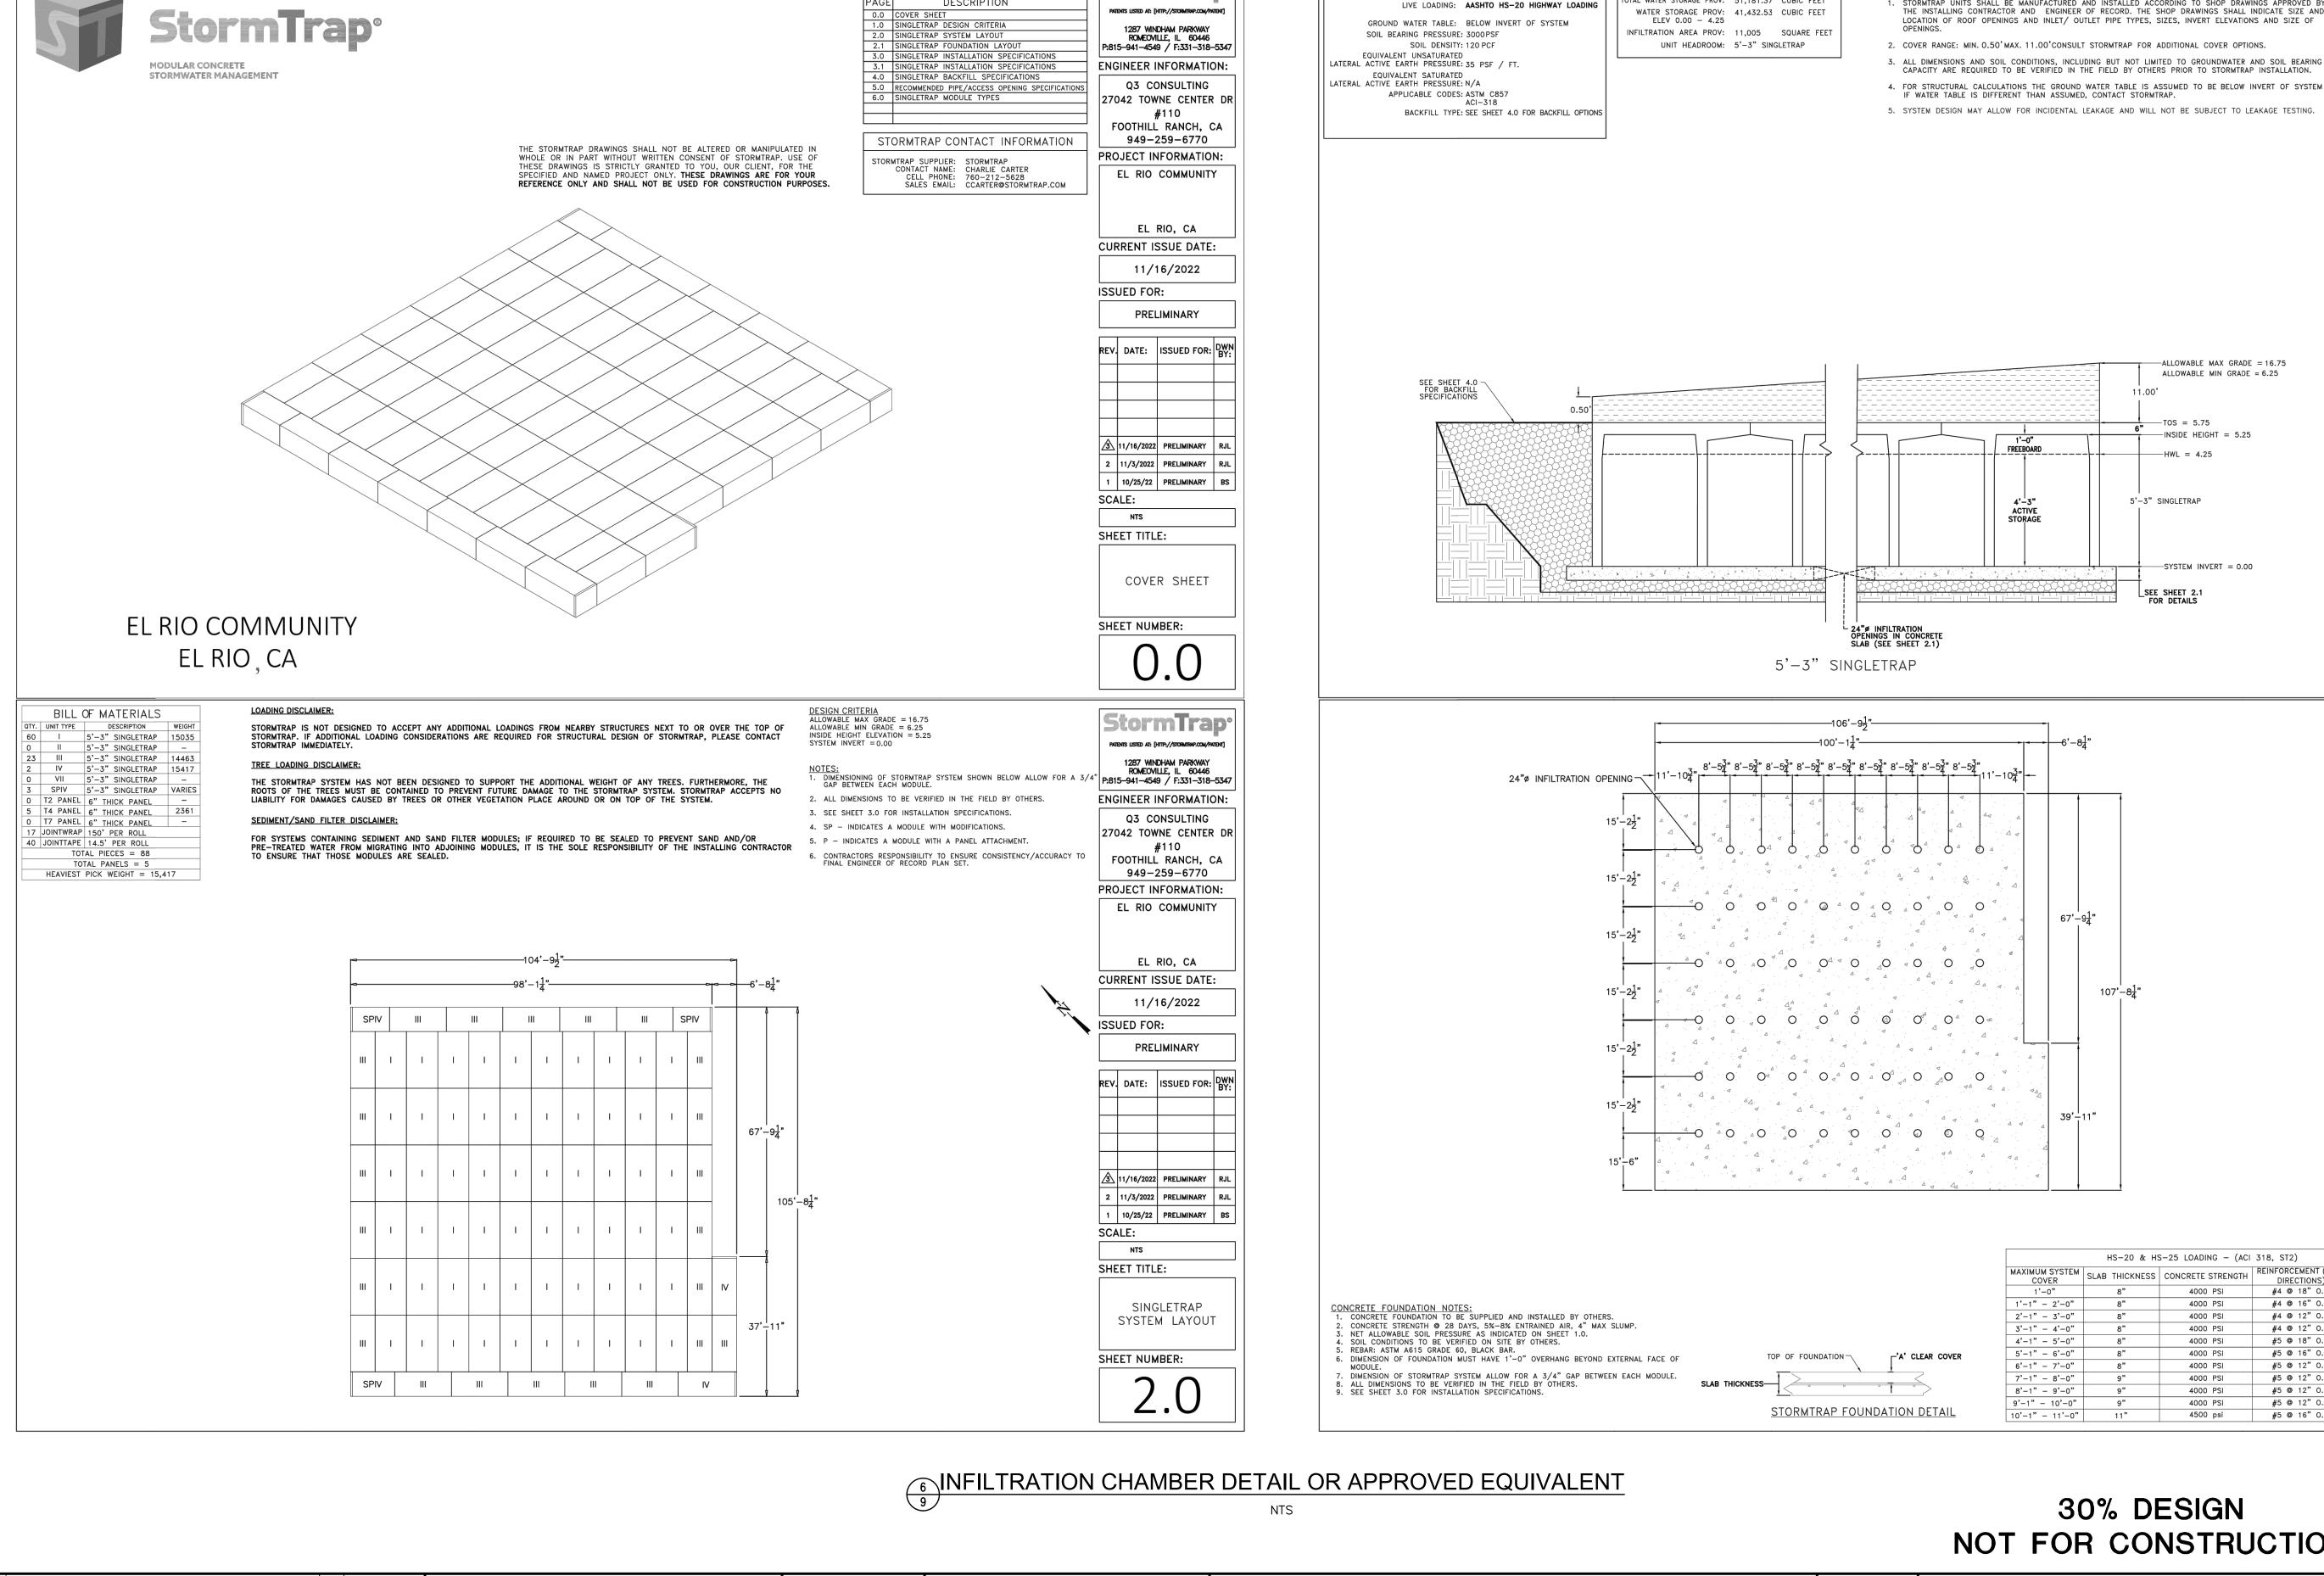


DESIGNED WATERSHED PROJECT MANAGER AR DRAWN WATERSHED DEPUTY DIRECTOR WATERSHED DIRECTOR

VENTURA COUNTY PUBLIC WORKS AGENCY WATERSHED PROTECTION

SPEC. NO. N/A PROJ. NO. N/A

PRETREATMENT DETAILS



DESIGNED

DRAWN

AR

Consulting

ISSUED FOR FEASIBILITY STUDY

11-29-22

27042 TOWNE CENTRE DRIVE, SUITE 110

FOOTHILL RANCH, CA 92610

949-259-6770

WATERSHED PROJECT MANAGER

WATERSHED DEPUTY DIRECTOR

WATERSHED DIRECTOR

SHEET INDEX

DESCRIPTION

StormTrap^o

STRUCTURAL DESIGN LOADING CRITERIA

VENTURA COUNTY

PUBLIC WORKS AGENCY

WATERSHED PROTECTION

30% DESIGN NOT FOR CONSTRUCTION

N/A

PROJ. NO.

N/A

SITE SPECIFIC DESIGN CRITERIA

1. STORMTRAP UNITS SHALL BE MANUFACTURED AND INSTALLED ACCORDING TO SHOP DRAWINGS APPROVED BY

-ALLOWABLE MAX GRADE = 16.75 ALLOWABLE MIN GRADE = 6.25

11.00

-TOS = 5.75 ---INSIDE HEIGHT = 5.25

-HWL = 4.25

SYSTEM INVERT = 0.00

5'-3" SINGLETRAP

STORMTRAP SYSTEM INFORMATION

TAL WATER STORAGE PROV: 51,181.37 CUBIC FEET

EL RIO STORMWATER CAPTURE AND **GROUNDWATER RECHARGE INFILTATION CHAMBER DETAILS 1**

SHEET ____11 13 DRAWING NO.

WP-?-???

NO. 77517

Expiration

06-30-23

'E' OF CALIFORN

StormTrap^o

PATENTS LISTED AT: [HTTP://STORMIRAP.COM/PATENT]

1287 WNDHAM PARKWAY ROMEOMILLE, IL 60446 P:815-941-4549 / F:331-318-5347

ENGINEER INFORMATION:

Q3 CONSULTING

27042 TOWNE CENTER DR

#110

FOOTHILL RANCH, CA

949-259-6770

PROJECT INFORMATION:

EL RIO COMMUNITY

EL RIO, CA **CURRENT ISSUE DATE:**

11/16/2022

PRELIMINARY

REV. DATE: ISSUED FOR: DWN

11/16/2022 PRELIMINARY RJL

2 11/3/2022 PRELIMINARY RJL

10/25/22 PRELIMINARY BS

SINGLETRAP

DESIGN

CRITERIA

StormTrap^o

PATENTS LISTED AT: [HTTP://STORMTRAP.COM/PATENT]

1287 WINDHAM PARKWAY ROMEOVILLE, IL 60446

P:815-941-4549 / F:331-318-5347

ENGINEER INFORMATION:

Q3 CONSULTING

27042 TOWNE CENTER DR

#110

FOOTHILL RANCH, CA

949-259-6770

PROJECT INFORMATION:

EL RIO COMMUNITY

EL RIO, CA

11/16/2022

PRELIMINARY

REV. DATE: ISSUED FOR: DWN

3 11/16/2022 PRELIMINARY

REINFORCEMENT (BOTH | 'A' CLEAR | SHEET TITLE:

3.875"

3.875"

3.875"

#4 @ 16" O.C.

#4 @ 12" O.C.

#4 @ 12" O.C.

#5 @ 18" O.C.

#5 @ 12" O.C.

#5 @ 12" O.C.

#5 @ 12" O.C.

#5 @ 16" O.C. 4.875"

4000 PSI

2 | 11/3/2022 | PRELIMINARY |

10/25/22 PRELIMINARY BS

SINGLETRAP

FOUNDATION

LAYOUT

SHEET NUMBER:

CURRENT ISSUE DATE:

ISSUED FOR:


ISSUED FOR:

SCALE:

NTS

SHEET NUMBER:

SHEET TITLE:

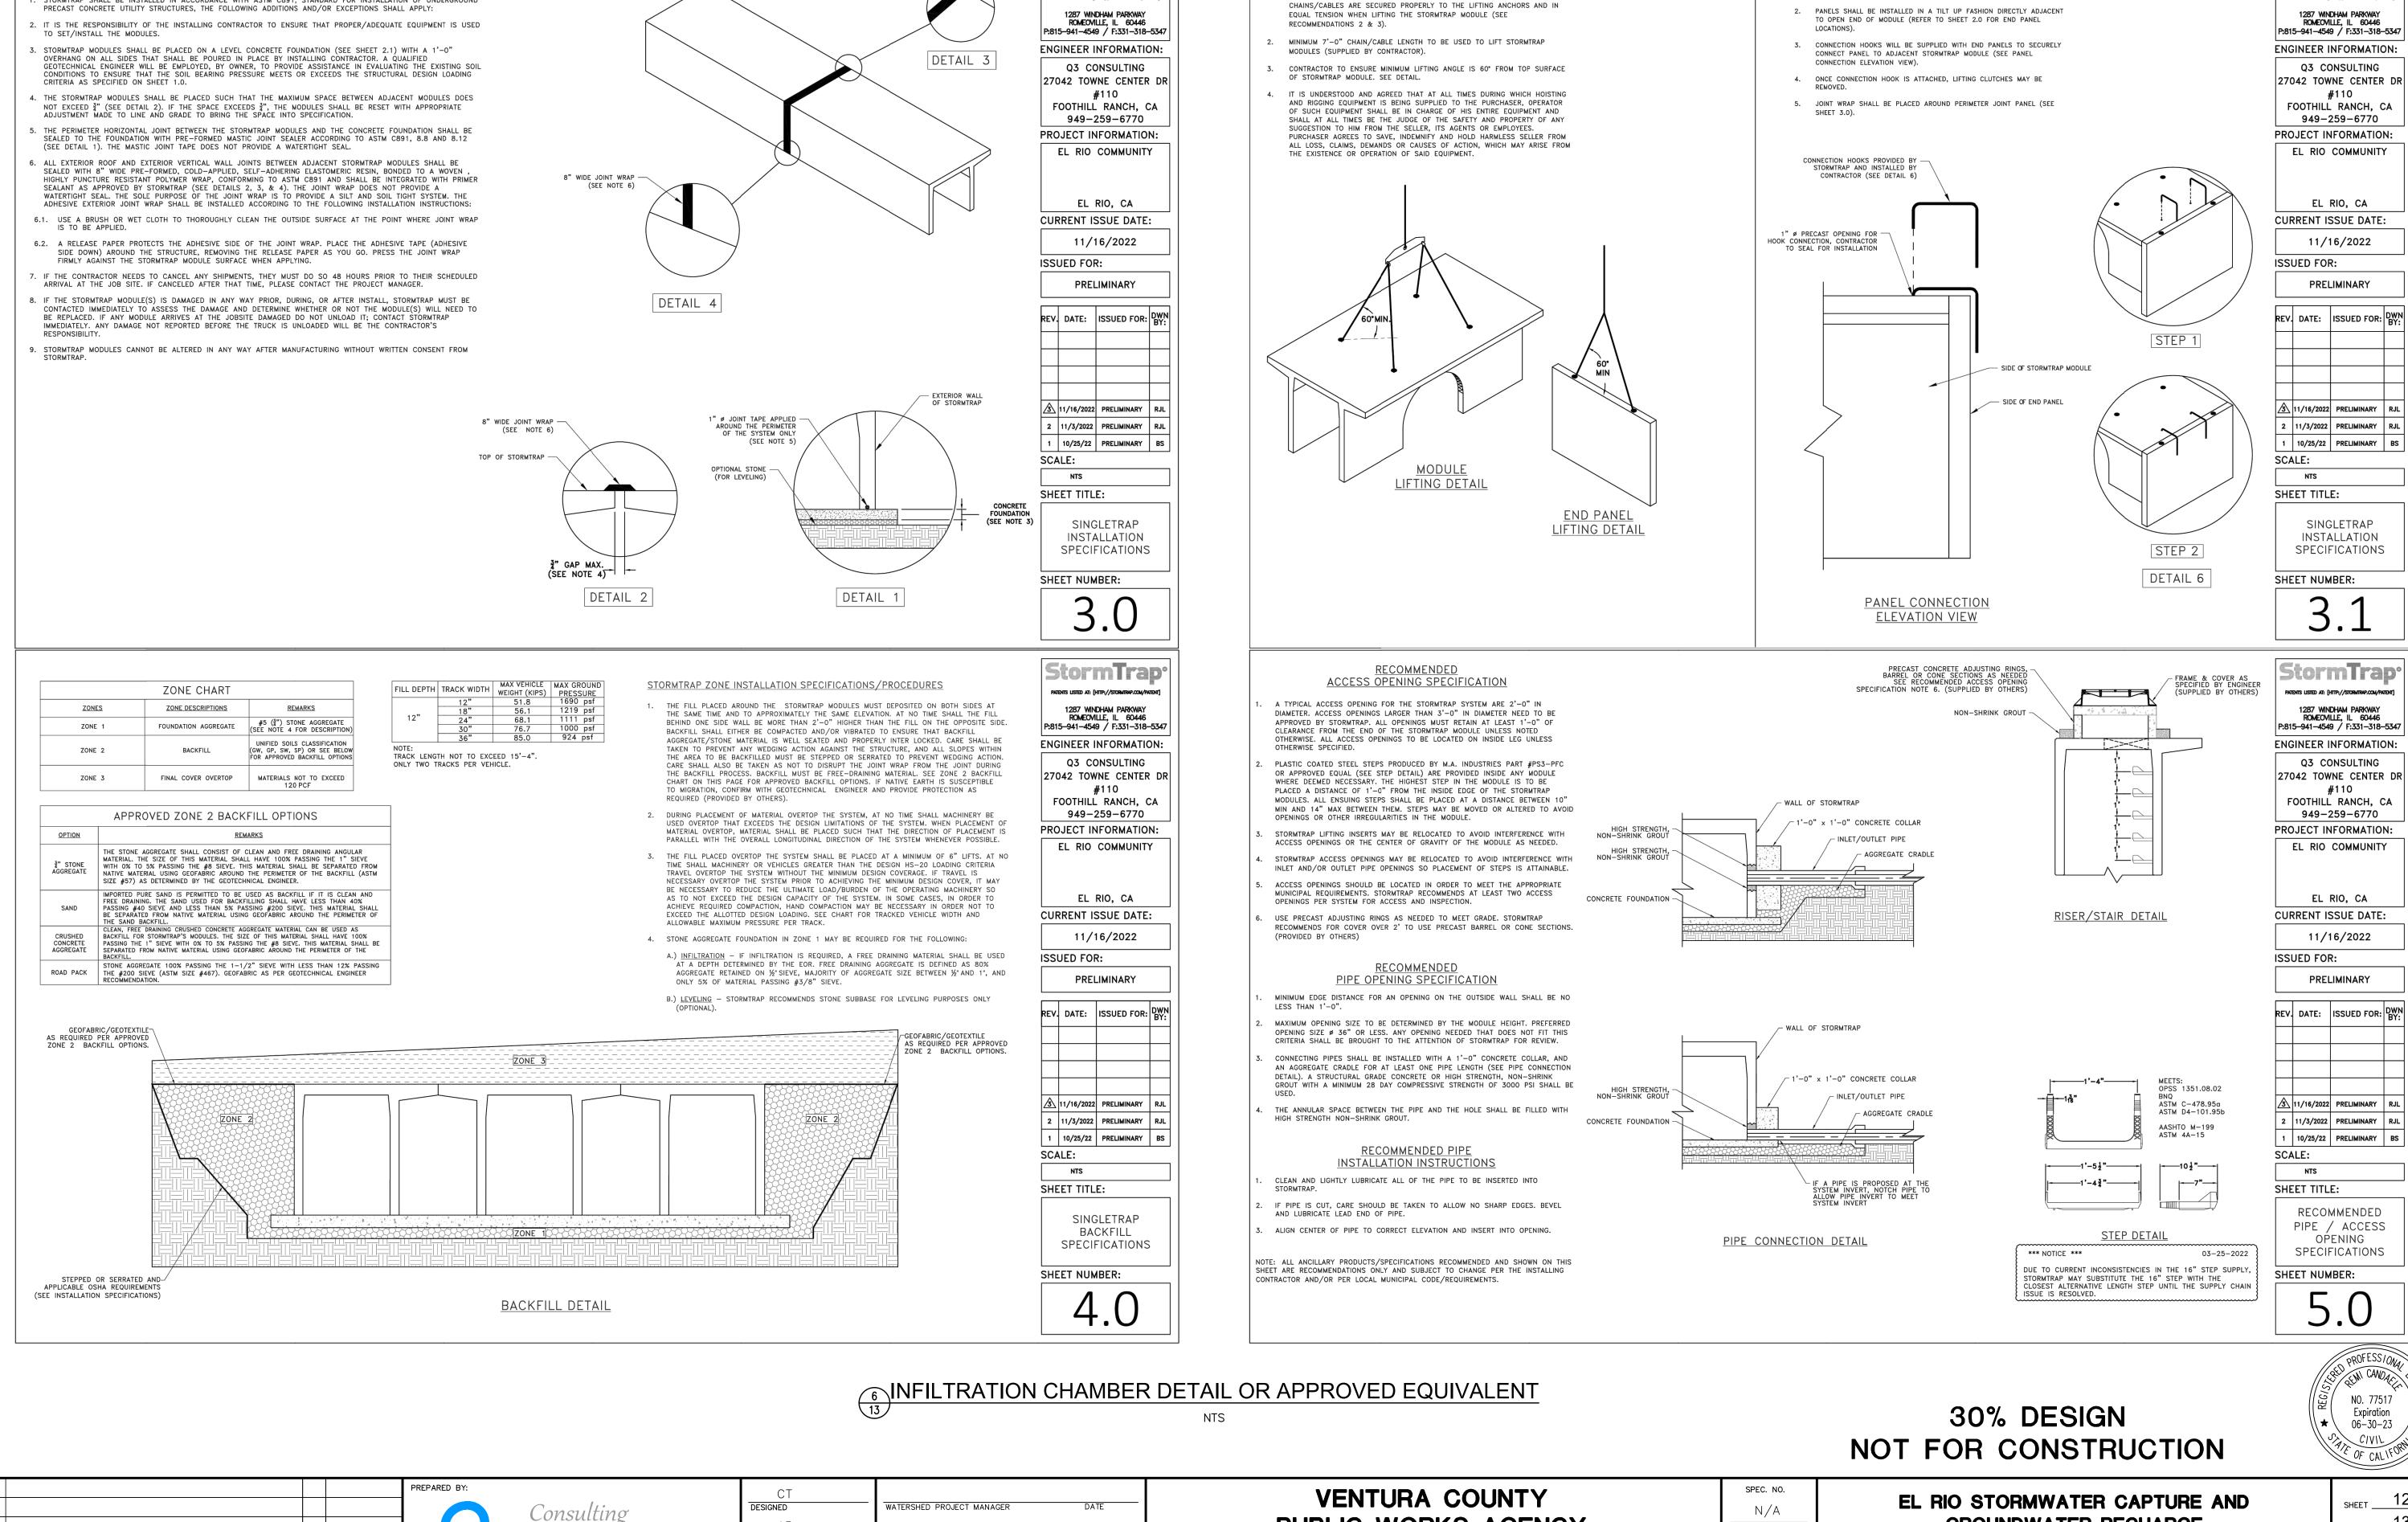

StormTrap^o

PATENTS LISTED AT: [HTTP://STORMTRAP.COM/PATENT

8" WIDE JOINT WRAP -

AR

WATERSHED DEPUTY DIRECTOR

WATERSHED DIRECTOR

DRAWN

7042 TOWNE CENTRE DRIVE, SUITE 110

FOOTHILL RANCH, CA 92610

949-259-6770

STORMTRAP INSTALLATION SPECIFICATIONS

. STORMTRAP SHALL BE INSTALLED IN ACCORDANCE WITH ASTM C891, STANDARD FOR INSTALLATION OF UNDERGROUND

ISSUED FOR FEASIBILITY STUDY

11-29-22

STORMTRAP MODULE LIFTING INSTALLATION NOTES

PUBLIC WORKS AGENCY

WATERSHED PROTECTION

. IT IS THE CONTRACTOR'S RESPONSIBILITY TO ENSURE THAT ALL (4)

GROUNDWATER RECHARGE INFILTATION CHAMBER DETAILS 2

PROJ. NO.

N/A


END PANEL ERECTION/INSTALLATION NOTES

1. END PANELS WILL BE SUPPLIED TO CLOSE OFF OPEN ENDS OF ROWS.

12 13 DRAWING NO. WP-?-???

StormTrap^o

PATENTS LISTED AT: [HTTP://STORMTRAP.COM/PATENT

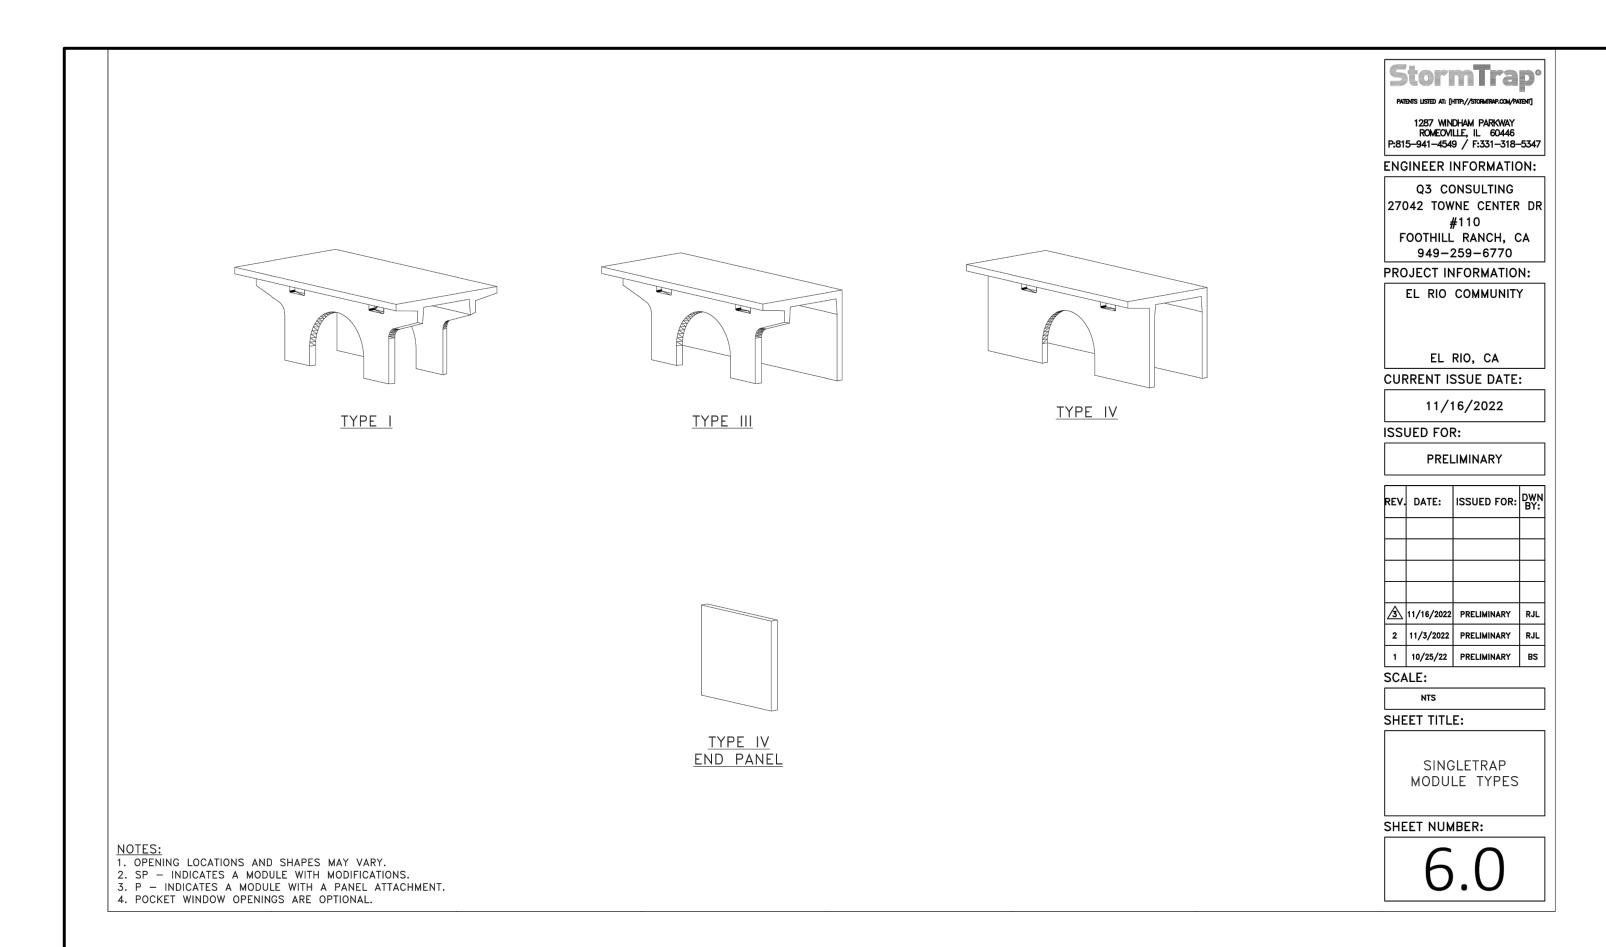

6 INFILTRATION CHAMBER DETAIL OR APPROVED EQUIVALENT

30% DESIGN NOT FOR CONSTRUCTION

EL RIO STORMWATER CAPTURE AND **GROUNDWATER RECHARGE INFILTATION CHAMBER DETAILS 3**

SHEET ____13___ of 13 DRAWING NO.

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	A	ISSUED FOR FEASIBILITY STUDY		11-29-22	
C	В				
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	D				

PREPARED BY: Consulting 27042 TOWNE CENTRE DRIVE, SUITE 110 FOOTHILL RANCH, CA 92610 949-259-6770

CT DESIGNED WATERSHED PROJECT MANAGER AR DRAWN WATERSHED DEPUTY DIRECTOR WATERSHED DIRECTOR

VENTURA COUNTY PUBLIC WORKS AGENCY WATERSHED PROTECTION

N/A PROJ. NO.

WP-?-???

NO. 77517 Expiration 06-30-23